

SITE DEVELOPMENT PLANS FOR 200-400 QUANNAPOWITT PARKWAY WAKEFIELD, MA 01880

OWNER: WATERSTONE PROPERTIES GROUP 117 KENDRICK STREET

APPLICANT:
CCF QUANNAPOWITT PROPERTY COMPANY, LLC
185 DARTMOUTH STREET, SUITE 402
BOSTON, MA 02116


SITE ENGINEERS:
ALLEN & MAJOR ASSOCIATES, INC.
100 COMMERCE WAY
WOBURN, MA 01888-0118

LAND SURVEYORS:
MERRILL
427 COLUMBIA ROAD
HANOVER, MA 02339
781.826.9200

LANDSCAPE ARCHITECTS:
COPLEY WOLFF DESIGN GROUP
10 POST OFFICE SQUARE, SUITE 1315
BOSTON, MA 02109


ARCHITECT:
CUBE 3 STUDIO
160 STATE STREET, FLOOR 6
BOSTON, MA 02109

TRAFFIC ENGINEERS:
VANASSE & ASSOCIATES, INC.
35 NEW ENGLAND BUSINESS CENTER DRIVE, SUITE 140
ANDOVER, MA 01810

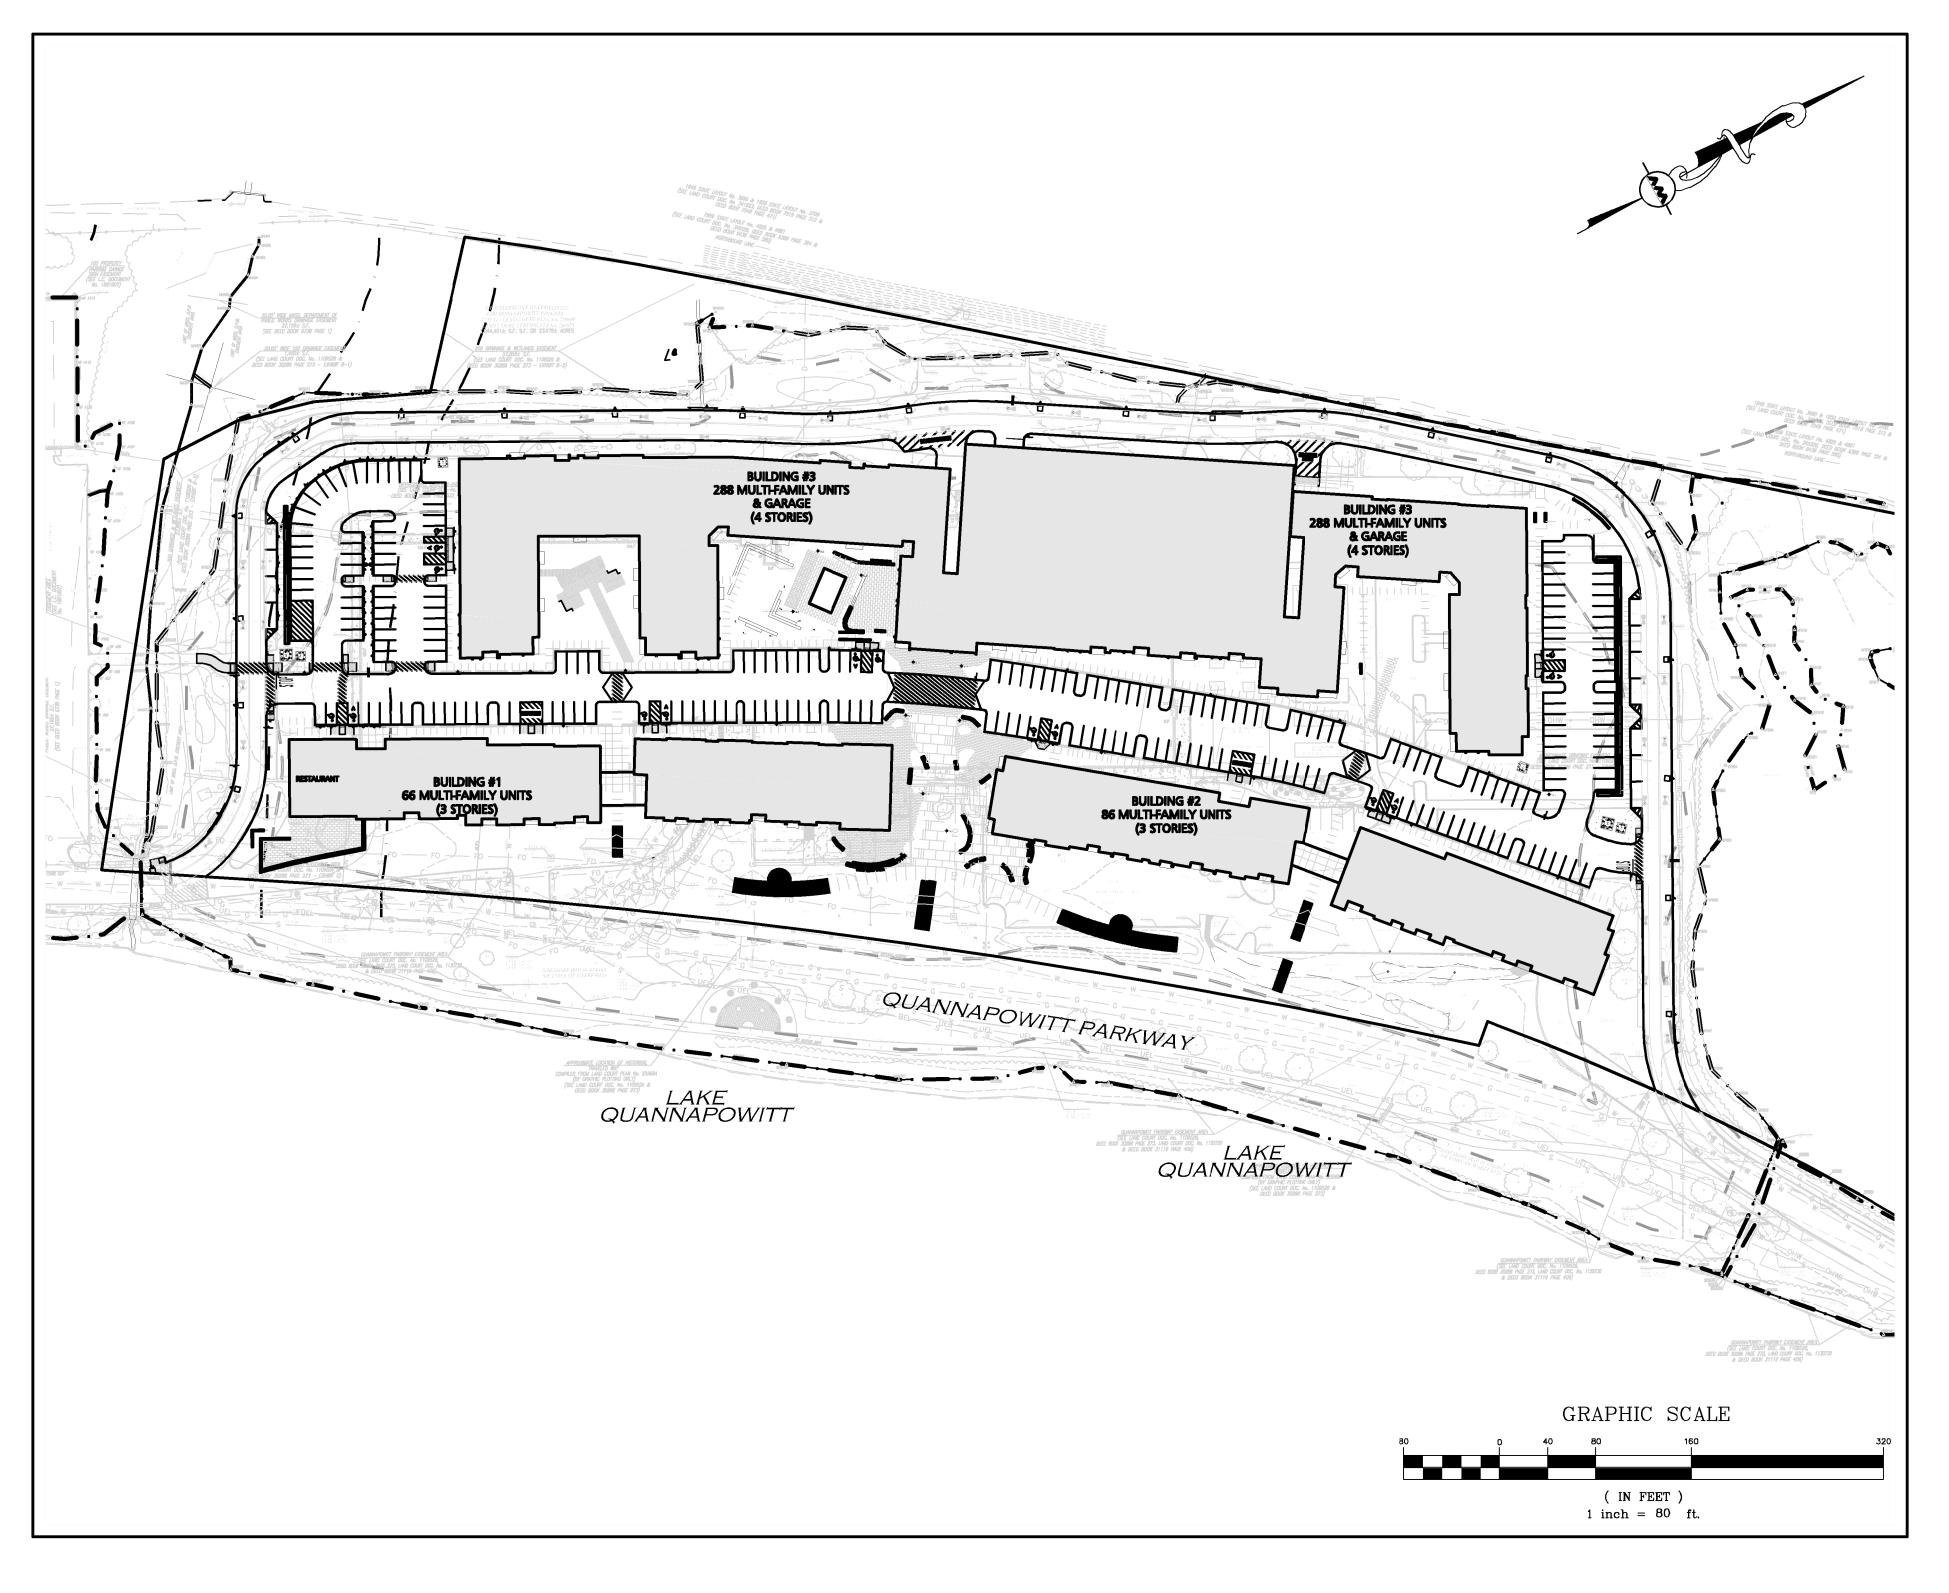

LIST OF DRAWINGS			
CIVIL			
DRAWING TITLE	SHEET NO.	ISSUED	REVISED THRU
EXISTING CONDITIONS PLAN	SHEET 2	05-23-2019	-
EXISTING CONDITIONS PLAN	SHEET 3	05-23-2019	-
EXISTING CONDITIONS PLAN	SHEET 4	05-23-2019	-
ABBREVIATIONS & NOTES	C-101A	03-16-2021	06-02-2022
CONTEXT PLAN	C-101B	03-16-2021	06-02-2022
EROSION CONTROL PLAN	C-102	03-16-2021	06-02-2022
SITE PREPARATION PLAN	C-103A/B	03-16-2021	06-02-2022
LAYOUT & MATERIALS PLAN	C-104A/B	03-16-2021	06-02-2022
GRADING & DRAINAGE PLAN	C-105A/B	03-16-2021	06-02-2022
UTILITY PLAN	C-106A/B	03-16-2021	06-02-2022
SITE LIGHTING PLAN	C-107A/B	03-16-2021	06-02-2022
FIRE TRUCK TURNING & HYDRANT LOCATION PLAN	C-108	03-16-2021	06-02-2022
AVERAGE GRADE PLAN	C-109A/B	03-16-2021	06-02-2022
DETAILS	C-501	03-16-2021	06-02-2022
DETAILS	C-502	03-16-2021	06-02-2022
DETAILS	C-503	03-16-2021	06-02-2022
DETAILS	C-504	03-16-2021	06-02-2022
DETAILS	C-505	03-16-2021	06-02-2022



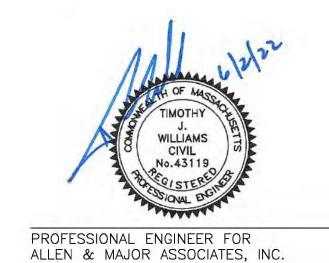



ISSUED TO ZONING BOARD OF APPEALS: MARCH 16, 2021
RE-ISSUED TO ZONING BOARD OF APPEALS: MARCH 31, 2021
ISSUED TO CONSERVATION COMMISSION: AUGUST 3, 2021
RE-ISSUED TO ZONING BOARD OF APPEALS: SEPTEMBER 1, 2021
RE-ISSUED TO ZONING BOARD OF APPEALS: NOVEMBER 11, 2021
RE-ISSUED TO CONSERVATION COMMISSION: JANUARY 5, 2022

RE-ISSUED TO CONSERVATION COMMISSION: FEBRUARY 7, 2022

RE-ISSUED TO CONSERVATION COMMISSION & ZONING BOARD OF APPEALS: APRIL 8, 2022

RE-ISSUED TO CONSERVATION COMMISSION & ZONING BOARD OF APPEALS: JUNE 2, 2022

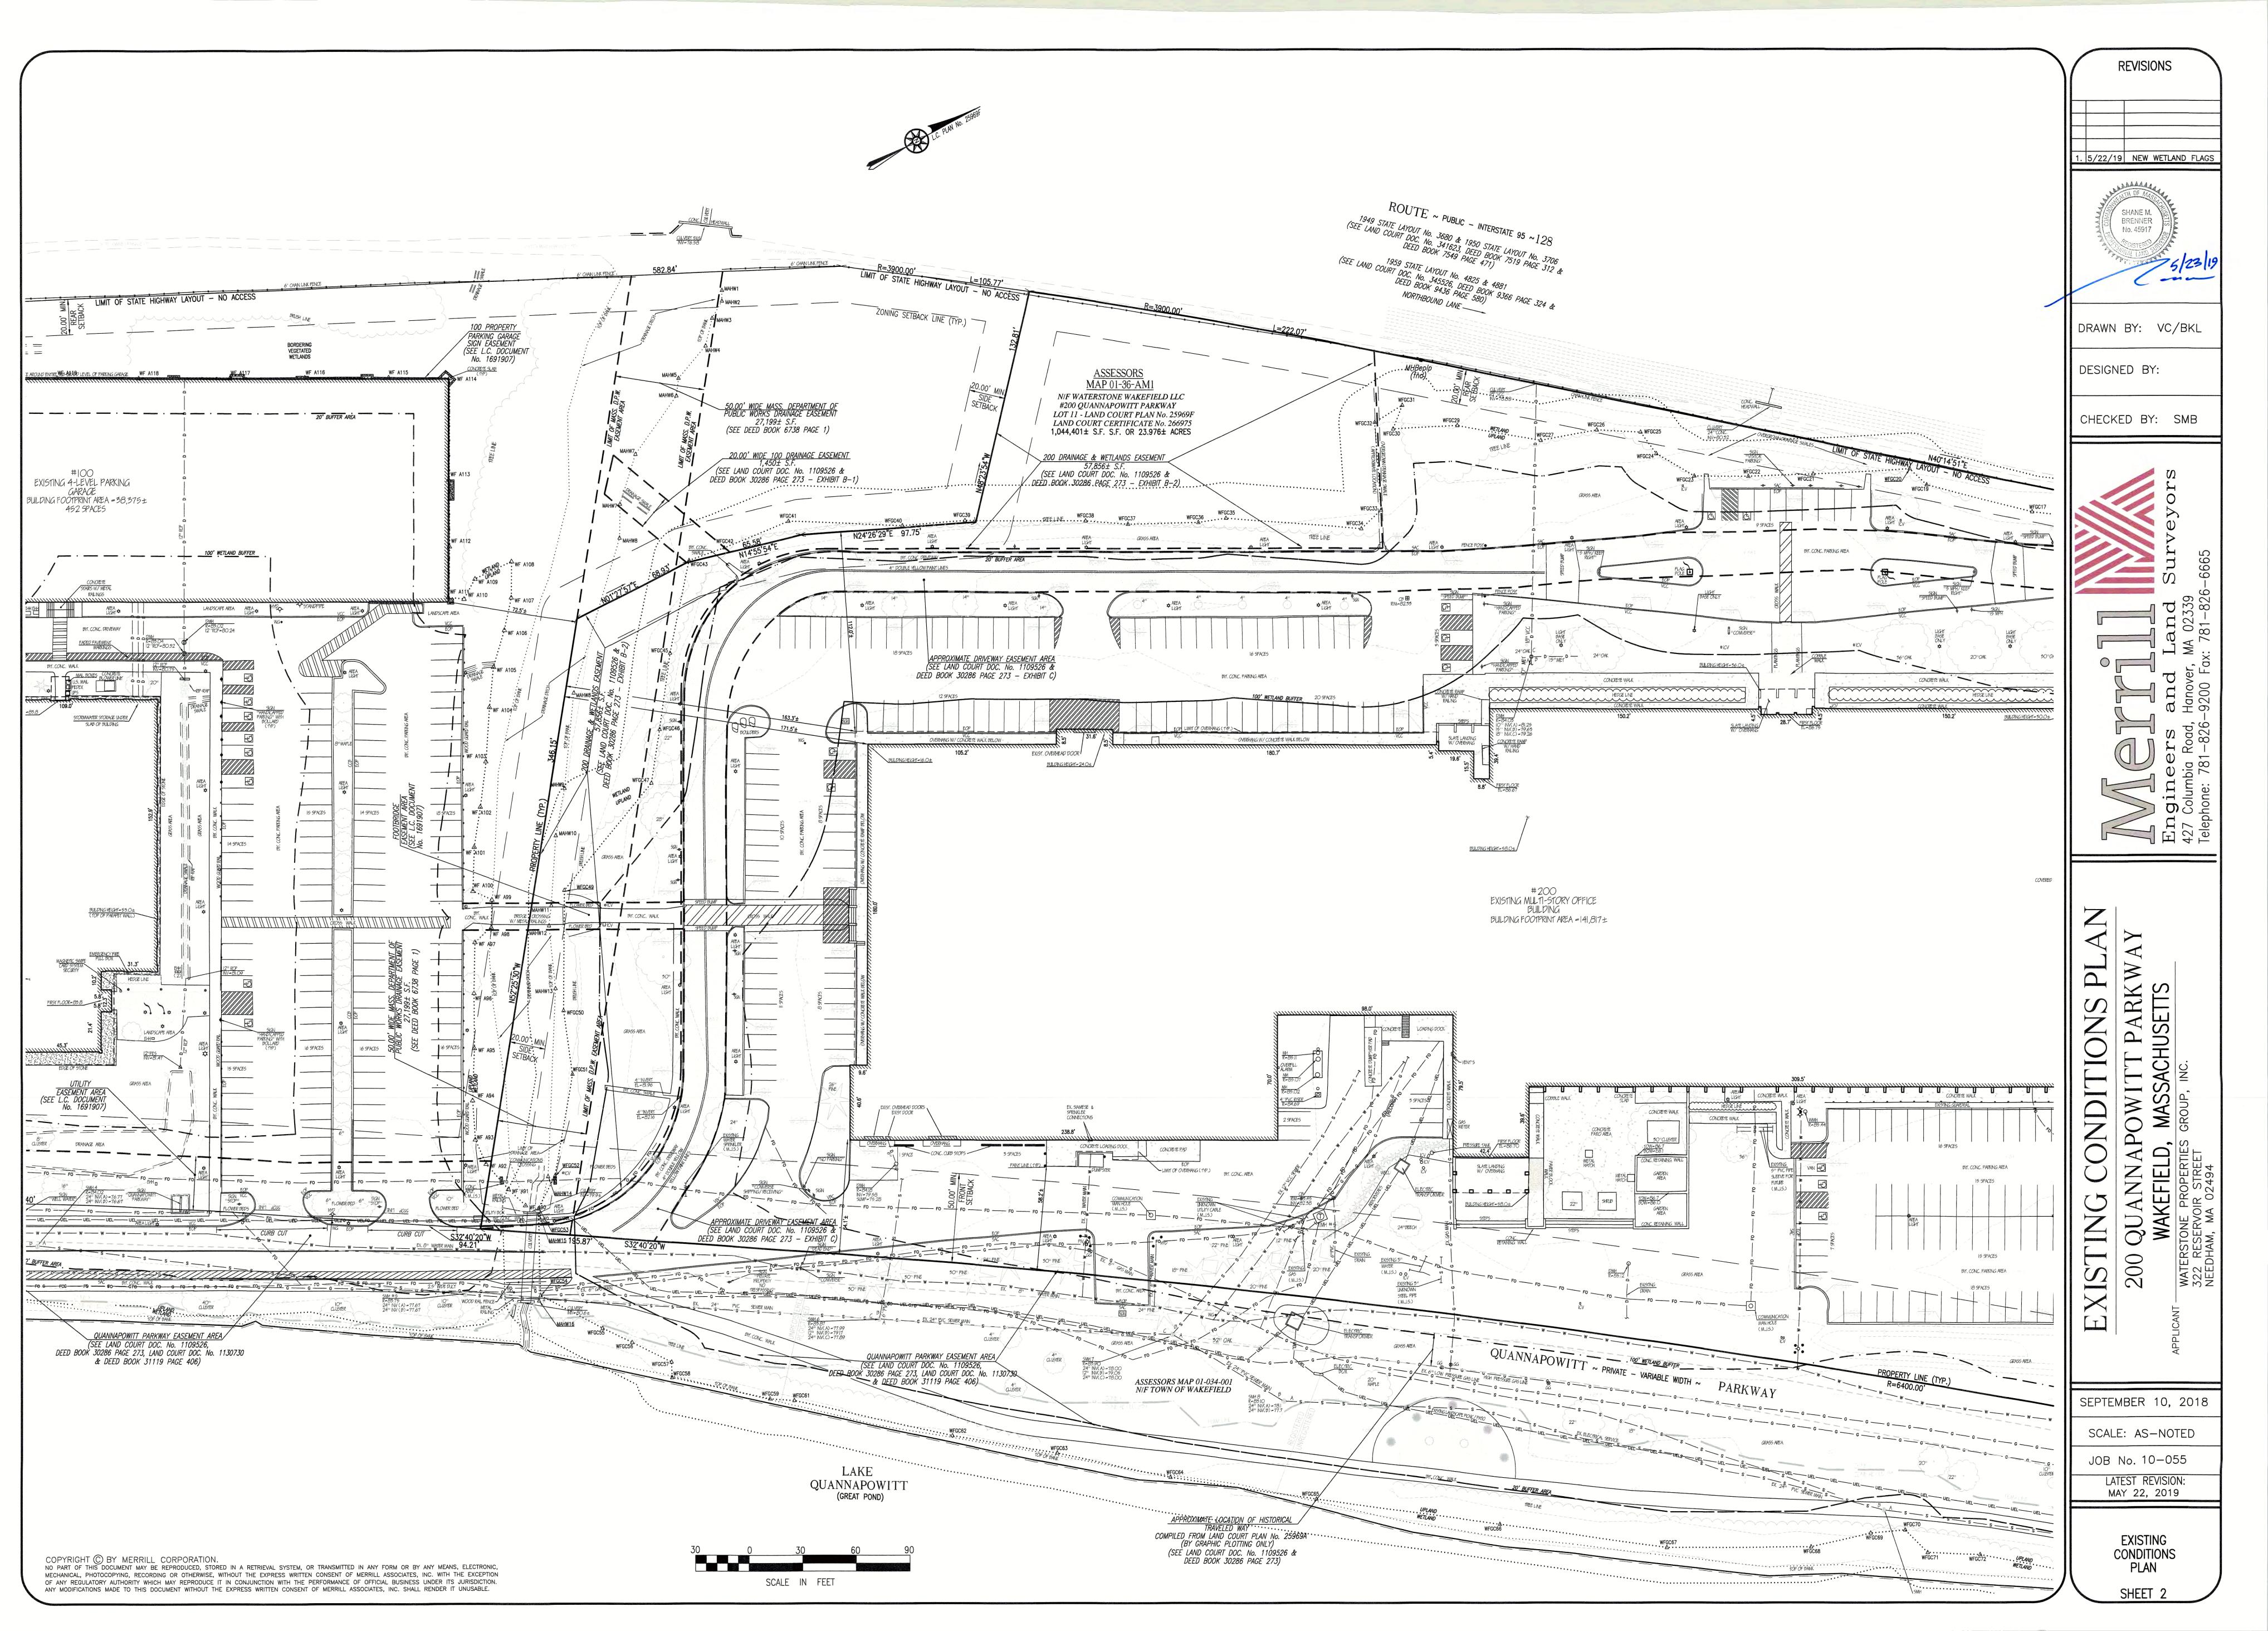

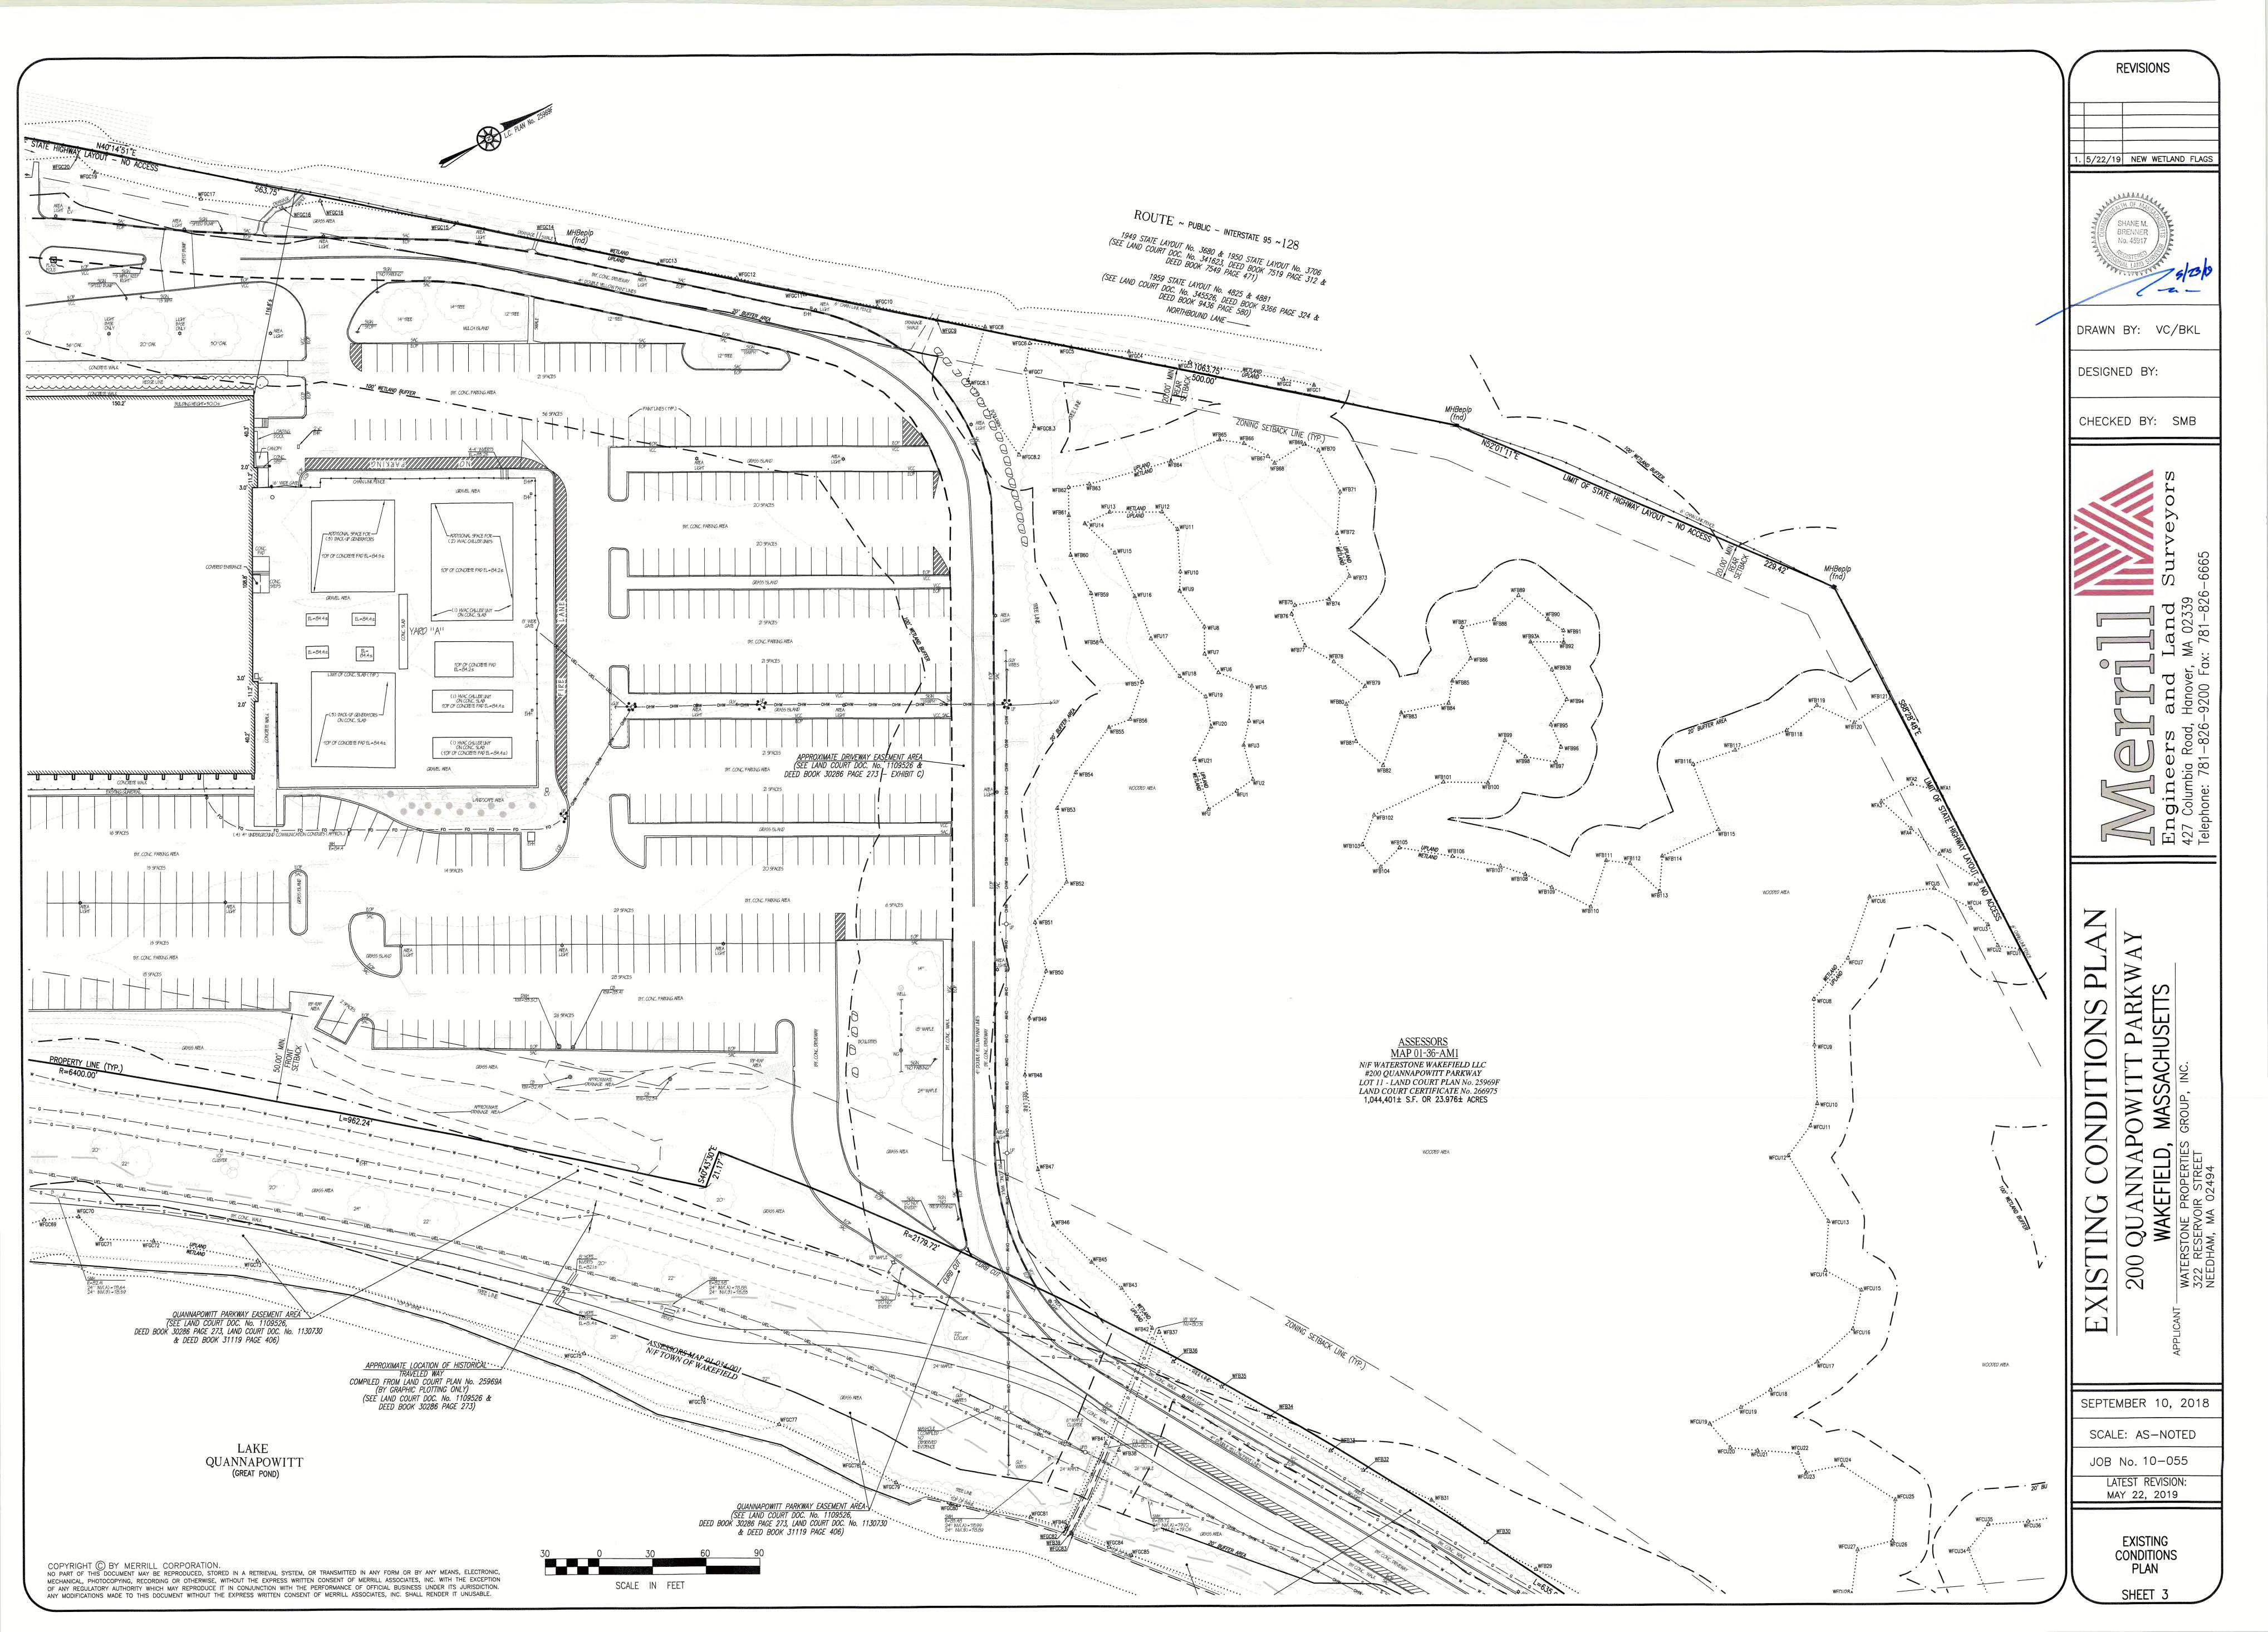



- THIS PROJECT WILL BE SERVED BY PUBLIC WATER AND SEWER, NATURAL GAS, TELEPHONE, CABLE AND ELECTRIC. ALL UTILITY LINES WILL BE INSTALLED UNDERGROUND UNLESS OTHERWISE NOTED.
- THE CONTRACTOR IS SPECIFICALLY CAUTIONED THAT THE LOCATION AND/OR ELEVATION OF EXISTING UTILITIES AND STRUCTURES AS SHOWN ON THESE PLANS IS BASED ON RECORDS OF VARIOUS UTILITY COMPANIES AND WHERE POSSIBLE, MEASUREMENTS TAKEN IN THE FIELD. THIS INFORMATION IS NOT TO BE RELIED ON AS BEING EXACT OR COMPLETE. THE LOCATION OF ALL UNDERGROUND UTILITIES AND STRUCTURES SHALL BE VERIFIED IN THE FIELD BY THE CONTRACTOR PRIOR TO THE START OF CONSTRUCTION. THE CONTRACTOR MUST CONTACT THE APPROPRIATE UTILITY COMPANY, ANY GOVERNING PERMITTING AUTHORITY. AND "DIGSAFE" AT LEAST 72 HOURS PRIOR TO ANY EXCAVATION WORK TO REQUEST EXACT FIELD LOCATION OF UTILITIES AND THE ENGINEER SHALL BE NOTIFIED IN WRITING OF ANY UTILITIES INTERFERING WITH THE PROPOSED CONSTRUCTION AND APPROPRIATE REMEDIAL ACTION TAKEN BEFORE PROCEEDING WITH THE WORK. IT SHALL BE THE RESPONSIBILITY OF THE CONTRACTOR TO RELOCATE ALL EXISTING UTILITIES WHICH CONFLICT WITH THE PROPOSED IMPROVEMENTS SHOWN ON THE PLANS AT NO ADDITIONAL COST.
- ALL MAIN BUILDING ENTRANCES AND WALKS SHALL BE HANDICAP ACCESSIBLE PER FEDERAL ADA & MA AAB REGULATIONS.
- ALL SITE WORK DONE FOR THIS PROJECT SHALL BE IN ACCORDANCE WITH THE SITE PLANS AND SITE WORK SPECIFICATIONS FOR CONSTRUCTION.
- ANY DAMAGE TO PRIVATE OR PUBLIC PROPERTIES DUE TO THE CONTRACTOR'S ACTIVITIES SHALL BE REPAIRED AND RESTORED BY THE CONTRACTOR AT THEIR OWN EXPENSE.
- 8. ALL PROPERTY MARKERS AND STREET LINE MONUMENTS SHALL BE PROPERLY PROTECTED DURING CONSTRUCTION. ANY DAMAGE TO THESE ITEMS SHALL BE REPAIRED AND RESTORED BY A SURVEYOR REGISTERED IN THE STATE OF MASSACHUSETTS AT THE CONTRACTORS EXPENSE.
- 9. ALL DISTURBED AREAS SHALL BE MAINTAINED IN ACCORDANCE WITH THE EROSION CONTROL PLAN, MA DEP. AND THE REQUIREMENTS OF THE WAKEFIELD CONSERVATION COMMISSION.
- 10. ALL APPLICABLE PERMITS AND AN APPROVED SET OF PLANS SHALL BE AVAILABLE AT THE CONSTRUCTION SITE.
- 11. THE CONTRACTOR IS RESPONSIBLE FOR SCHEDULING A PRECONSTRUCTION MEETING THE WITH THE APPROPRIATE TOWN DEPARTMENTS, THE APPROPRIATE UTILITY COMPANIES, THE OWNER AND OWNER'S REPRESENTATIVE. THE MEETING SHALL TAKE PLACE PRIOR TO THE START OF CONSTRUCTION AND THE CONTRACTOR MUST PROVIDE 48 HOURS NOTICE TO ALL ATTENDEES PRIOR TO THE START OF THE MEETING.
- 12. APPROPRIATE WARNING SIGNS, MARKERS, BARRICADES AND/OR FLAG MEN SHALL BE PROVIDED TO REGULATE TRAFFIC. CONSTRUCTION TRAFFIC CONTROLS SHALL BE IMPLEMENTED AND OPERATED ACCORDING TO THE MASS DEPARTMENT OF TRANSPORTATION, THE MANUAL ON UNIFORM TRAFFIC CONTROL DEVICES (MUTCD) AND THE LOCAL AUTHORITY.
- 13. THE CONTRACTOR IS RESPONSIBLE FOR OBTAINING ADDITIONAL BENCHMARK INFORMATION IF REQUIRED. THE CONTRACTOR IS RESPONSIBLE FOR LOCATING AND PROTECTING ALL EXISTING BENCHMARKS. IF IT IS NECESSARY TO RELOCATE A BENCHMARK, IT SHALL BE RELOCATED BY A MASSACHUSETTS PROFESSIONAL LAND SURVEYOR AND DONE SO AT THE CONTRACTOR'S
- 14. ALL PERMITS AND APPROVALS NECESSARY FROM AGENCIES GOVERNING THE WORK SHALL BE OBTAINED BY THE CONTRACTOR PRIOR TO THE COMMENCEMENT OF WORK.
- 15. ALL BUILDING DIMENSIONS ARE MEASURED TO THE OUTSIDE FACE OF THE BUILDING.
- 16. ALL RADII ARE 3 FEET UNLESS OTHERWISE NOTED.
- 17. ALL PARKING LOT AND AISLE DIMENSIONS ARE TAKEN FROM THE FACE OF CURB AND INDICATE EDGE OF PAVEMENT.
- 18. IT IS THE CONTRACTORS RESPONSIBILITY TO ENSURE THAT EROSION AND SEDIMENTATION CONTROL MEASURES SHALL BE IN PLACE PRIOR TO THE COMMENCEMENT OF ANY SITE WORK OR EARTHWORK OPERATIONS. SHALL BE MAINTAINED DURING CONSTRUCTION, AND SHALL REMAIN IN PLACE UNTIL ALL SITE WORK IS COMPLETE AND GROUND COVER IS ESTABLISHED. ADDITIONAL EROSION CONTROL MEASURES SHALL BE INSTALLED IF DEEMED NECESSARY PER ON SITE INSPECTIONS OF THE OWNER, THEIR REPRESENTATIVES, OR REGULATORY AGENCIES HAVING JURISDICTION AT NO ADDITIONAL COST TO THE
- 19. CONSTRUCTION DURING WET WEATHER OR WINTER CONDITIONS IS TO BE ANTICIPATED AND PROVISIONS TO ADEQUATELY ADDRESS THESE CONDITIONS SHALL BE THE RESPONSIBILITY OF THE CONTRACTOR AT NO ADDITIONAL COST.
- 20. THE CONTRACTOR IS RESPONSIBLE FOR OBTAINING AND PAYING FOR ANY PERMITS AND/OR CONNECTION FEES REQUIRED TO CARRY OUT THE WORK INCLUDING BUT NOT LIMITED TO DEMOLITION.
- 21. DISPOSAL OF ALL DEMOLISHED MATERIALS INCLUDING EXISTING MISC. CONSTRUCTION DEBRIS FILL IS THE RESPONSIBILITY OF THE CONTRACTOR AND MUST BE DISPOSED OF OFF-SITE IN ACCORDANCE WITH ALL FEDERAL, STATE, AND LOCAL MUNICIPAL REQUIREMENTS AT NO ADDITIONAL COST.
- 22. ALL DISTURBED AREAS NOT NOTED TO RECEIVE OTHER TREATMENT ARE TO RECEIVE SIX INCHES (6") MINIMUM OF TOPSOIL & SEED, AND BE MAINTAINED UNTIL ESTABLISHED & ACCEPTED. SEE LANDSCAPE PLAN.
- 23. EXISTING STRUCTURES WITHIN CONSTRUCTION LIMITS ARE TO BE ABANDONED, REMOVED OR RELOCATED AS NECESSARY.
- 24. CONTRACTOR SHALL BE RESPONSIBLE FOR ALL RELOCATIONS, INCLUDING BUT NOT LIMITED TO, ALL UTILITIES, STORM DRAINAGE, SIGNS, TRAFFIC SIGNALS & POLES, ETC. AS REQUIRED. ALL WORK SHALL BE IN ACCORDANCE WITH THE TOWN OF WAKEFIELD'S GOVERNING AUTHORITY'S SPECIFICATIONS AND SHALL BE
- 25. THE CONTRACTOR SHALL COORDINATE WITH ALL UTILITY COMPANIES TO DETERMINE EXACT POINT OF SERVICE CONNECTION AT EXISTING UTILITY.
- 26. ALL ELEVATIONS SHOWN ARE IN REFERENCE TO THE BENCHMARK AND MUST BE VERIFIED BY THE GENERAL CONTRACTOR AT GROUNDBREAK.
- PROPOSED GAS SERVICE LOCATIONS ARE APPROXIMATE ONLY. THE CONTRACTOR SHALL CONFIRM WITH THE GAS COMPANY THAT THE GAS LINE INSTALLATION SHALL BE BY THE LOCAL GAS COMPANY. THE CONTRACTOR SHALL GIVE THE GAS COMPANY ADVANCE NOTICE OF WHEN THE GAS LINE CAN BE INSTALLED.
- 28. PROPOSED ELECTRIC AND COMMUNICATIONS (TELEPHONE AND CABLE) SYSTEMS LOCATIONS ARE APPROXIMATE ONLY AND SHALL BE COORDINATED AND SCHEDULED WITH THE APPROPRIATE UTILITY COMPANY SERVICING THE PROJECT
- 29. CONTRACTOR IS RESPONSIBLE FOR DIGGING TEST HOLES AND VERIFYING ANY EXISTING UTILITY OR STRUCTURE PRIOR TO CONSTRUCTION, CONTRACTOR SHALL VERIFY THAT BASED ON EXACT LOCATION OF EXISTING UTILITIES, THERE ARE NO CONFLICTS BETWEEN THEM AND THE PROPOSED UTILITIES.

UTILITY NOTES:

- THE LATEST STANDARDS OF THE TOWN OF WAKEFIELD SHALL BE FOLLOWED WHEN INSTALLING ANY SANITARY SEWER AND STORM DRAIN WORK. BOTH SEWER AND STORM DRAIN WORK WILL BE INSPECTED BY TOWN OF WAKEFIELD PERSONNEL AND ALL COSTS SHALL BE THE RESPONSIBILITY OF THE CONTRACTOR.
- 2. THE LATEST STANDARDS OF THE TOWN OF WAKEFIELD SHALL BE FOLLOWED WHEN INSTALLING ANY WATER LINE WORK. WATER LINE WORK WILL BE INSPECTED BY TOWN OF WAKEFIELD PERSONNEL AND ALL COSTS SHALL INCLUDE PRESSURE TESTING, DISINFECTING, AND FLUSHING OF LINES. INSPECTION COSTS SHALL BE THE RESPONSIBILITY OF THE CONTRACTOR. THE CONTRACTOR SHALL BE RESPONSIBLE FOR INSTALLATION AND REMOVAL OF ALL NECESSARY DISINFECTING AND FLUSHING TAPS AS DIRECTED BY THE TOWN.
- THE CONTRACTOR SHALL REFER TO ARCHITECTS & PLUMBING PLANS AND SPECIFICATIONS FOR ACTUAL LOCATION OF ALL ROOF DRAIN LATERALS AND UTILITY ENTRANCES TO INCLUDE SANITARY SEWER LATERALS, DOMESTIC AND FIRE PROTECTION WATER SERVICE, ELECTRIC, TELEPHONE, AND NATURAL GAS SERVICE. THE CONTRACTOR SHALL COORDINATE INSTALLATION OF UTILITIES IN SUCH A MANNER AS TO AVOID CONFLICTS AND COORDINATE WITH THE PROPER AGENCY THE LOCATION AND SCHEDULING OF CONNECTIONS WITH THEIR FACILITIES.
- WHERE AN EXISTING UTILITY IS FOUND TO CONFLICT WITH THE PROPOSED WORK, THE LOCATION, ELEVATION AND SIZE OF THE UTILITY SHALL BE ACCURATELY DETERMINED WITHOUT DELAY BY THE CONTRACTOR, AND THE INFORMATION FURNISHED TO THE ENGINEER FOR RESOLUTION.
- ABANDONED EXISTING UTILITIES AND UTILITIES TO BE ABANDONED SHALL EITHER BE ABANDONED IN PLACE AS NOTED OR SHALL BE REMOVED AND DISPOSED OF AS SPECIFIED. ALL UTILITIES SCHEDULED FOR ABANDONMENT OR REMOVAL AND DISPOSAL MUST BE COORDINATED BY THE CONTRACTOR WITH THE RESPECTIVE UTILITY OWNER. WHEN ABANDONED UTILITIES ARE TO BE LEFT IN PLACE, PLUG OR CAP THE ENDS OF THE CONDUITS AND PIPES. REMOVE ABANDONED UTILITY MANHOLES. JUNCTION BOXES AND SIMILAR STRUCTURES TO A MINIMUM DEPTH OF 4 FEET BELOW FINISHED GRADE AND PUNCTURE OR BREAK THE BOTTOM SLABS OF MANHOLES AND SIMILAR STRUCTURE TO ALLOW DRAINAGE. BACKFILL AND COMPACT EXCAVATIONS RESULTING FROM REMOVAL OF UTILITY FACILITATES, AS REQUIRED TO RESTORE THE ORIGINAL GRADE.
- 6. THE CONTRACTOR SHALL MAKE ARRANGEMENTS FOR THE ALTERATION AND ADJUSTMENTS OF NATURAL GAS, ELECTRIC, TELEPHONE AND ANY OTHER UTILITY BY THE UTILITY OWNER.
- THE CONTRACTOR SHALL USE THE FOLLOWING PIPE MATERIALS: SEWER - PVC (POLYVINYL CHLORIDE), SDR 35 DRAIN — HDPE (HIGH DENSITY CORRUGATED POLYETHYLENE PIPE WITH SMOOTH INNER WALL). ASTM D2321 (UNLESS OTHERWISE SPECIFIED ON PLAN) - RCP CLASS IV (REINFORCED CONCRETE PIPE, WHERE SPECIFIED) WATER - C.L.D.I.
- 8. BEFORE WORK BEGINS ON THE SEWER OR STORM DRAIN, THE CONTRACTOR WILL COORDINATE WITH THE TOWN OF WAKEFIELD THE APPROPRIATE PERMIT FEE AND INSPECTION FEE.
- 9. ALL UTILITY CONNECTIONS THROUGH THE BUILDING WALL SHALL BE BY MEANS OF FLEXIBLE JOINTS.
- 10. A MINIMUM OF 10 FEET CLEAR HORIZONTALLY SHALL BE MAINTAINED BETWEEN WATER MAINS AND SANITARY SEWER MAINS AND/OR STORM DRAINS. WHENEVER CONDITIONS PREVENT A LATERAL SEPARATION OF 10 FEET TO A WATER MAIN. THE WATER MAIN SHALL BE LAID IN A SEPARATE TRENCH AND THE DIFFERENCE IN ELEVATION BETWEEN THE WATER MAIN AND THE SEWER
- 11. ALL FILL MATERIAL IS TO BE IN PLACE, AND COMPACTED BEFORE INSTALLATION
- 12. CONTRACTOR SHALL NOTIFY THE UTILITY AUTHORITY'S INSPECTORS 72 HOURS BEFORE CONNECTING TO ANY EXISTING LINE.
- 13. MINIMUM TRENCH WIDTH SHALL BE 2 FEET.
- 14. CONTRACTOR SHALL MAINTAIN A MINIMUM OF 5'-0" COVER ON ALL WATERLINES AND A MAXIMUM OF 8'-0" COVER.
- 15. IN THE EVENT OF A VERTICAL CONFLICT BETWEEN WATERLINES, SANITARY LINES, STORM LINES AND GAS LINES (EXISTING AND PROPOSED). THE SANITARY LINE SHALL BE DUCTILE IRON PIPE WITH MECHANICAL JOINTS AT LEAST 10 FEET ON BOTH SIDES OF CROSSING. THE WATERLINE SHALL HAVE MECHANICAL JOINTS WITH APPROPRIATE THRUST BLOCKING AS REQUIRED TO PROVIDE A MINIMUM OF 18" CLEARANCE BETWEEN THE PIPES. WHERE THE WATERLINE IS LESS THE 18" VERTICAL CLEARANCE AND MEETING 10' HORIZONTAL CLEARANCE CANNOT BE MET. THE WATER MUST BE ENCASED IN CONCRETE TO MEET THE REQUIREMENTS OF ANSI A21.10 OR ANSI 21.11 (AWWA C-151) (CLASS 50).
- 16. ALL CONCRETE FOR ENCASEMENTS SHALL HAVE A MINIMUM 28 DAY COMPRESSION STRENGTH OF 3000 P.S.I.
- 17. DRAWINGS DO NOT NECESSARILY SHOW ALL EXISTING UTILITIES.
- 18. CONTRACTOR IS RESPONSIBLE FOR COMPLYING WITH THE SPECIFICATIONS OF THE LOCAL AUTHORITIES WITH REGARDS TO MATERIALS AND INSTALLATION OF THE WATER, SEWER, GAS AND ELECTRICAL AND TELECOMMUNICATIONS LINES.
- 19. ALL NECESSARY INSPECTIONS AND/OR CERTIFICATIONS REQUIRED BY CODES AND/OR UTILITY SERVICE COMPANIES SHALL BE PERFORMED PRIOR TO ANNOUNCED BUILDING POSSESSION AND THE FINAL CONNECTION OF SERVICE.
- 20. ALL WATER MAIN APPURTENANCES, MATERIALS, METHODS OF INSTALLATION AND TESTING REQUIREMENTS SHALL MEET OR EXCEED THE TOWN OF WAKEFIELD
- 21. SEWER PIPE BEDDING MATERIAL SHALL BE AS SPECIFIED ON THE DRAWINGS. IF LOCAL OR STATE AUTHORITIES REQUIRE DIFFERENT BEDDING OR BACKFILL MATERIAL, THEN THE MORE STRINGENT SHALL APPLY.

EROSION & SEDIMENTATION CONTROL NOTES:

- EROSION CONTROL SHALL BE INSTALLED PRIOR TO CONSTRUCTION AND SHALL BE ADEQUATE TO MAINTAIN SEDIMENT ON SITE. ANY MODIFICATIONS TO SILT CONTROLS SHOWN ON THE APPROVED PLANS AS A RESULT OF ACTUAL FIELD CONDITIONS OR CONSTRUCTION PRACTICES SHALL BE INSTALLED IN ACCORDANCE WITH B.M.P. (BEST MANAGEMENT PRACTICES) PER THE E.P.A. 2008 "CONSTRUCTION GENERAL PERMIT" MANUAL. AND MASSACHUSETTS 2003 EROSION & SEDIMENT CONTROL GUIDELINES FOR URBAN AND SUBURBAN AREAS, . ANY SUCH MODIFICATIONS FROM THE ABOVE MANUALS SHALL BE INSTALLED AS APPROVED BY THE ENGINEER.
- AREAS OF EXPOSED SOIL UNDERGOING CONSTRUCTION THAT WILL NOT BE COVERED AND OR FINISHED GRADED SHALL BE STABILIZED AS SOON AS PRACTICABLE BUT IN NO CASE MORE THAN 14 DAYS AFTER THE CONSTRUCTION ACTIVITY (UNLESS TOWN HAS STRICTER REQUIREMENTS WHICH SHALL BE FOLLOWED) IN THAT PORTION OF THE SITE HAS TEMPORARILY OR PERMANENTLY CEASED. TEMPORARY EROSION CONTROL MEASURES SHALL INCLUDE EROSION CONTROL MESH, NETTING OR MULCH AS DIRECTED BY THE OWNER'S REPRESENTATIVE AND SHOWN ON THE DESIGN PLANS. IF MULCH IS USED, STRAW MULCH SHALL BE APPLIED AT THE RATE OF 4 BALES PER 1.000 SQUARE FEET. APPLICATION AREA SHALL BE SUFFICIENTLY COVERED WITH MULCH TO AVOID ANY VISIBLE SOIL EXPOSURE. MULCH SHALL BE KEPT MOIST TO AVOID LOSS DUE TO WIND. MULCH AND NETTING SHALL BE APPLIED IN THE BASE OF ALL GRASSED WATERWAYS AND IN VEGETATIVE SLOPES WHICH EXCEED 15% AND DISTURBED AREAS WITHIN 100 FEET OF WETLANDS OR STREAMS.
- 3. IF DISTURBED AREAS DO NOT RECEIVE FINAL SEEDING BY OCTOBER 1ST OF THE CONSTRUCTION YEAR, THEN ALL DISTURBED AREAS SHALL BE SEEDED WITH A WINTER COVER CROP AT THE RATE OF 3 LBS PER 1,000 SQUARE FEET. WINTER SEEDING SHALL BE COVERED WITH EROSION CONTROL MESH (MULCH AND NETTING). HEAVY GRADE MATS SHALL BE USED IN THE BASE OF ALL GRASSED WATERWAYS ON VEGETATED SLOPES IN EXCESS OF 15%, AND ANY DISTURBED AREAS WITHIN 100 FEET OF WETLANDS OR STREAMS. MULCH AND NETTING SHALL ALSO BE PROVIDED FOR ADDITIONAL WINTER PROTECTION.
- 4. ALL TOPSOIL SHALL BE COLLECTED, STOCKPILED, SEEDED WITH RYE AT 3LBS PER 1.000 SQUARE FOOT AND MULCHED, AND REUSED AS REQUIRED. SILTATION FENCING SHALL BE PLACED DOWN GRADIENT FROM STOCKPILED LOAM. LOAM SHALL BE STOCKPILED AT LOCATIONS DESIGNATED BY THE OWNER AND ENGINEER.
- 5. ALL FILTER BARRIERS, SILT SACKS, AND EROSION CONTROL BERMS SHALL BE INSTALLED ACCORDING TO THE EROSION CONTROL PLAN. THESE SHALL BE MAINTAINED DURING DEVELOPMENT TO REMOVE SEDIMENT FROM RUNOFF WATER. ALL THE FILTER BARRIERS AND EROSION CONTROL BERMS SHALL BE INSPECTED AFTER ANY RAINFALL OR RUNOFF EVENT, MAINTAINED AND CLEANED UNTIL ALL AREAS HAVE AT LEAST 85-90% VIGOROUS PERENNIAL COVER OF GRASSES.
- ADJACENT ROADS SHALL BE PERIODICALLY SWEPT OR WASHED TO AVOID TRACKING MUD, DUST OR DEBRIS FROM THE CONSTRUCTION AREA. A WATERING TRUCK WILL BE USED TO PERIODICALLY SPRINKLE CONSTRUCTION AREAS IN ORDER TO KEEP THE LEVEL OF DUST TO A MINIMUM DURING THE DRY MONTHS.
- 7. THE CONTRACTOR SHALL USE EXTREME CAUTION TO AVOID ALLOWING SEDIMENTS TO ENTER THE STORM DRAIN SYSTEM DURING CONSTRUCTION. CATCH BASIN INLETS SHALL BE PROTECTED DURING CONSTRUCTION BY THE USE OF STRAW BALE BARRIERS AROUND EACH INLET. SILT SACKS SHALL BE INSTALLED IN ALL EXISTING BASINS. INLET PROTECTION MAY BE REMOVED ONLY AFTER FINISHED AREAS ARE PAVED AND THE VEGETATED SLOPES ARE ESTABLISHED WITH AT LEAST 85-90% OF VIGOROUS PERENNIAL GROWTH.
- 8. AS APPLICABLE, EROSION CONTROL MESH SHALL BE APPLIED IN ACCORDANCE WITH THE PLANS OVER ALL FINISHED SEEDED AREAS AS SPECIFIED ON THE DESIGN PLANS.
- 9. AT A MINIMUM, ALL STRAW BALE AND FILTER FABRIC SHALL REMAIN IN PLACE UNTIL SEEDINGS HAVE BECOME 85-90% ESTABLISHED. THE TOWN OF WAKEFIELD CONSERVATION COMMISSION MUST APPROVE THE REMOVAL OR RELOCATION OF ANY OF THE STRAW BALES AND FILTER FABRIC.
- 10. AT THE OWNER'S DISCRETION ADDITIONAL EROSION CONTROL MEASURES MAY BE REQUIRED TO MAINTAIN STABILITY OF EARTHWORKS AND FINISHED GRADED AREAS. THE CONTRACTOR, AT HIS EXPENSE, WILL BE RESPONSIBLE FOR PROVIDING AND INSTALLING ANY ADDITIONAL MEASURES AS SPECIFIED BY THE OWNER. THIS INCLUDES BUT IS NOT LIMITED TO REQUESTS BY MA DEP. THE ENGINEER AND THE MUNICIPALITY, AS AUTHORIZED BY THE OWNER. FAILURE TO COMPLY WITH THE OWNER'S DIRECTIONS WILL RESULT IN DISCONTINUATION OF CONSTRUCTION ACTIVITIES.
- 11. INSPECTIONS AND MONITORING MAINTENANCE MEASURES SHALL BE APPLIED AS NEEDED DURING THE ENTIRE CONSTRUCTION CYCLE BY CONTRACTOR. WEEKLY INSPECTIONS SHALL BE HELD THROUGH THE DURATION OF CONSTRUCTION ACTIVITY. WEEKLY INSPECTION REPORTS SHALL BE MAINTAINED BY THE CONTRACTOR AND LOCATED IN THE CONTRACTORS FIELD OFFICE ONSITE. IN ADDITION TO THE NORMAL WEEKLY INSPECTIONS, THE CONTRACTOR SHALL PERFORM AN INSPECTION OF ALL EROSION CONTROL MEASURES AFTER EACH RAINFALL OR RUNOFF EVENT, KEEP APPROPRIATE REQUIRED RECORDS AND INSPECTION REPORTS, AND PERFORM THE NECESSARY REPAIRS. THE INSPECTIONS SHALL INCLUDE BUT NOT BE LIMITED TO THE SITE'S DOWN STREAM DISCHARGE POINTS.
- 12. IF ANY EVIDENCE OF SEDIMENTATION IS OBSERVED AT THE STORMWATER MANAGEMENT AREA INLETS. THE CONTRACTOR SHALL. AT HIS OWN EXPENSE. PROVIDE A PLAN TO THE ENGINEER TO REMOVE ANY ACCUMULATED SEDIMENT IN THESE AREAS. THE CONTRACTOR SHALL ALSO IMMEDIATELY PROVIDE ADDITIONAL ON SITE EROSION AND SEDIMENTATION CONTROL MEASURES TO PREVENT FURTHER DEGRADATION OF THE AREA.
- 13. FOLLOWING THE TEMPORARY OR FINAL SEEDINGS, THE CONTRACTOR SHALL INSPECT THE WORK AREA SEMI-MONTHLY TO ENSURE THE AREAS HAVE A MINIMUM OF 85-90% VEGETATED VIGOROUS GROWTH. RE-SEEDING SHALL BE CARRIED OUT BY THE CONTRACTOR WITH FOLLOW UP INSPECTIONS IN THE EVENT OF ANY FAILURES UNTIL VEGETATION IS ADEQUATELY ESTABLISHED.
- 14. CONTRACTOR & ALL SITE SUBCONTRACTORS SHALL BE FAMILIAR WITH & FOLLOW ALL APPROVED PERMITS AND CONDITIONS. CONTRACTOR SHALL MAINTAIN A COPY OF ALL APPROVED PERMITS ONSITE, INCLUDING THE ORDER OF CONDITIONS FROM THE WAKEFIELD CONSERVATION COMMISSION. ALL CONDITIONS & RECOMMENDATIONS WITHIN THE APPROVED PERMITS SHALL BE COMPLETED AT NO ADDITIONAL COST TO THE OWNER.
- 15. ALL EROSION MEASURES SHALL BE INSTALLED PRIOR TO CONSTRUCTION AND SHALL BE ADEQUATE TO MAINTAIN SEDIMENT ON SITE. ANY MODIFICATIONS SHALL BE INSTALLED AS DIRECTED BY THE ENGINEER OR THE TOWN OF WAKEFIELD.
- 16. EROSION AND SEDIMENTATION CONTROL MEASURES SHALL BE MAINTAINED DURING CONSTRUCTION, AND SHALL REMAIN IN PLACE UNTIL ALL SITE WORK IS COMPLETE AND GROUND COVER IS ESTABLISHED.
- 17. TOP OF STOCKPILES SHALL BE COVERED IN SUCH MANNER THAT STORMWATER DOES NOT INFILTRATE THE MATERIALS AND THEREBY RENDER THE SAME UNSUITABLE FOR FILL USE.
- 18. ALL DISTURBED OR EXPOSED AREAS SUBJECT TO EROSION SHALL BE STABILIZED WITH MULCH OR SEEDED FOR TEMPORARY VEGETATIVE COVER. NO AREA. SUBJECT TO EROSION SHALL BE LEFT DISTURBED AND UNSTABILIZED FOR PERIODS LONGER THAN IS ABSOLUTELY NECESSARY TO CARRY OUT THAT PORTION OF THE CONSTRUCTION WORK OR SIX MONTHS AFTER SOIL HAS BEEN DISTURBED WHICHEVER IS LESS.
- 19. ALL EROSION CONTROL MEASURES SHALL BE ROUTINELY INSPECTED. CLEANED AND REPAIRED OR REPLACED AS NECESSARY THROUGHOUT ALL PHASES OF CONSTRUCTION. IN ADDITION, INSPECTION SHALL TAKE PLACE WEEKLY AND BEFORE AND AFTER EACH RAINFALL EVENT.
- 20. ALL PROPOSED SLOPES EQUAL TO OR STEEPER THAN 3:1 SHALL BE STABILIZED WITH JUTE MESH AND PROTECTED FROM EROSION UNTIL WORK IS COMPLETE AND GROUND COVER IS ESTABLISHED.
- 21. THE CONTRACTOR SHALL KEEP ON SITE AT ALL TIMES ADDITIONAL HAYBALES AND EXTRA SILTATION FENCING FOR INSTALLATION AT THE DIRECTION OF THE ENGINEER OR THE TOWN ENGINEER TO MITIGATE ANY EMERGENCY CONDITION.

GRADING & DRAINAGE NOTES:

- 1. EXISTING PAVEMENT SHALL BE SAW-CUT AND PAVEMENT JOINT SHALL BE INSTALLED WHERE NECESSARY TO ENSURE A SMOOTH CONTINUOUS GRADE.
- 2. THE ARCHITECTURAL PLANS SHALL BE REFERRED TO IN ORDER TO DETERMINE THE EXACT LOCATIONS OF VESTIBULE, SLOPED PAVING, EXIT PORCHES, HANDICAPPED RAMPS, TRUCK DOCKS, DUMPSTER PADS, ROOF DRAIN LATERALS AND PRECISE BUILDING DIMENSIONS.
- 3. ALL GRADING OPERATIONS SHALL BE COORDINATED WITH THE APPROPRIATE UTILITY COMPANIES.
- 4. IN LANDSCAPED AREAS THE TOP ELEVATION OF MANHOLES SHALL BE FLUSH WITH FINISH GRADE OF THE LOAM. IN PAVED AREAS THE TOP ELEVATIONS OF MANHOLES SHALL MATCH FINISH GRADE.
- 5. ALL AREAS DISTURBED DURING CONSTRUCTION SHALL BE STABILIZED AS SOON AS POSSIBLE UPON COMPLETION OF CONSTRUCTION WORK IN THE AREA. REFER TO EROSION CONTROL PLAN.
- 6. TEMPORARY STRAW BALE PROTECTION AND/OR SILT SACK SHALL BE INSTALLED AND MAINTAINED AT EXISTING DRAINAGE STRUCTURES DURING CONSTRUCTION, TO PRECLUDE SEDIMENT LADEN RUNOFF FROM ENTERING THE DRAINAGE SYSTEM.
- 7. CONTRACTOR IS RESPONSIBLE FOR DEMOLITION OF EXISTING STRUCTURES INCLUDING REMOVAL OF ANY EXISTING UTILITIES SERVING THE STRUCTURE.
- 8. ALL CATCH BASINS. MANHOLES. INFILTRATION SYSTEM. AND WATER QUALITY STRUCTURES TO BE CLEANED OUT PRIOR TO FINAL APPROVAL TO REMOVE ALL CONSTRUCTION SILT AND DEBRIS.
- 9. IF ANY EXISTING UTILITY STRUCTURES TO REMAIN ARE DAMAGED DURING CONSTRUCTION IT SHALL BE THE CONTRACTOR'S RESPONSIBILITY TO REPAIR AND/OR REPLACE THE EXISTING STRUCTURE AS NECESSARY TO RETURN IT TO EXISTING CONDITIONS OR BETTER AT NO ADDITIONAL COST.
- 10. ALL STORM PIPE ENTERING STRUCTURES SHALL BE GROUTED TO ASSURE CONNECTION AT STRUCTURE IS WATERTIGHT.
- 11. ALL STORM DRAIN MANHOLES SHALL HAVE TRAFFIC BEARING RING & COVERS & SHALL BE LABELED "DRAIN".
- 12. THE CONTRACTOR SHALL ADHERE TO ALL TERMS & CONDITIONS AS OUTLINED IN THE GENERAL N.P.D.E.S. PERMIT FOR STORM WATER DISCHARGE ASSOCIATED WITH CONSTRUCTION ACTIVITIES.
- 13. CONTRACTOR SHALL ASSURE POSITIVE DRAINAGE AWAY FROM BUILDINGS FOR ALL NATURAL AND PAVED AREAS.
- 14. ALL UNSURFACED AREAS DISTURBED BY GRADING OPERATION SHALL RECEIVE SIX INCHES (6") OF TOPSOIL CONTRACTOR SHALL APPLY STABILIZATION FABRIC TO ALL SLOPES EQUAL TO OR STEEPER THAN 3H:1V. CONTRACTOR SHALL GRASS DISTURBED AREAS IN ACCORDANCE WITH LANDSCAPE & CIVIL SPECIFICATIONS & DRAWINGS UNTIL A HEALTHY STAND OF GRASS IS OBTAINED.
- 15. ALL DRAINAGE SHALL CONFORM TO LOCAL REQUIREMENTS.

ABBREVIATIONS:

	<u>10113.</u>		
ABAN ADJ	ABANDON ADJUST	L LB LP	LENGTH LEACHING BASIN LIGHT POLE
B BC BIT BCB BLDG BM BOS BOW BRK	BORING BOTTOM OF CURB BITUMINOUS BITUMINOUS CONCRETE BERM BUILDING BENCH MARK BOTTOM OF SLOPE BOTTOM OF WALL BRICK	MAT MAX MH MIN MISC MTD MW	MATERIAL MAXIMUM MANHOLE MINIMUM MISCELLANEOUS MOUNTED MONITORING WELL
BV&B BVW	BUTTERFLY VALVE & BOX BORDERING VEGETATED WETLAND CABLE TELEVISION	N NIC NO NTS	NORTH NOT IN CONTRACT NUMBER NOT TO SCALE
CB CF CFS CI CL CLDI	CATCH BASIN CUBIC FEET CUBIC FEET PER SECOND CAST IRON (PIPE) CENTERLINE CEMENT LINED DUCTILE IRON (PIPE)	OC OD OHW OVHD OW	ON CENTER OUTSIDE DIAMETER OVERHEAD WIRE OVERHEAD OBSERVATION WELL
CLDI CM CMP CO CONC CONST CONT CRD CPP CUL CY	CONSTRUCTION MANAGER CORRUGATED METAL PIPE CLEAN OUT CONCRETE CONSTRUCTION CONTRACTOR COORDINATE CORRUGATED POLYETHYLENE PIPE CULVERT CUBIC YARD	PC PCC PI PKG PL PLMB POC POT PRC PROP, P	POINT (OR POINT OF TANGENT)
DB DBL DEM DET DI DIA DIM DMH DW DWG DYCL	DIAMFTER	PVC R&R R&S RCP RD RED RELOC REM RET ROW RR RWL	REINFORCED CONCRETE PIPE ROAD (OR ROOF DRAIN) REDUCER RELOCATE REMOVE RETAIN, RETAINING OR RETENTION RIGHT OF WAY RAILROAD
EHH EL ELEC EMH EOP EOR EOW ETC EXIST EXT		RWY SD SF SGC SMH SP SPEC STA STC STD	SUBDRAIN SQUARE FEET SLOPED GRANITE CURB SEWER MANHOLE STANDPIPE SPECIFICATION STATION STORMCEPTOR STANDARD STRUCTURAL
FA FCC FES FFE FLNP FPS FS FT	FIRE ALARM FLUSH CONCRETE CURB FLARED END SECTION FINISH FLOOR ELEVATION FIRE LANE NO PARKING FEET PER SECOND FIRE SERVICE FOOT/FEET	SW SWLL SYCL TB TC TD TEL, T	SIDEWALK SOLID WHITE LANE LINE SOLID YELLOW CENTERLINE TEST BORING TOP OF CURB TRENCH DRAIN TELEPHONE
GC GEN GG GR GRAN	GENERAL CONTRACTOR GENERAL GAS GATE GUIDE RAIL GRANITE	TMH TOS TOW TP TS&V TYP	TELEPHONE MANHOLE TOP OF SLOPE TOP OF WALL TEST PIT TAPPING SLEEVE & VALVE TYPICAL
GV GV&B GW	GATE VALVE GATE VALVE & BOX GROUND WATER	UD UL UP	UNDERDRAIN UNDERWRITERS LABORATORY UTILITY POLE
HOR HT HW HWY HYD	HORIZONTAL HEIGHT HEADWALL HIGHWAY HYDRANT	VCP VERT VGC	VITRIFIED CLAY PIPE VERTICAL VERTICAL GRANITE CURB
ID IN INCL INST INV. I.E.	INSIDE DIAMETER INCHES INCLUDE INSTALLED INVERT. INVERT ELEVATION	WD WG WM WMH WSO WMGLD	WOOD WATER GATE WATER MAIN WATER MANHOLE WATER SHUTOFF WAKEFIELD MUNICIPAL GAS & LIGHT DEPARTMENT

WILLIAMS CIVIL No.43119

PROFESSIONAL ENGINEER FOR ALLEN & MAJOR ASSOCIATES, INC.

8 | 06/02/2022 | Re-Issued to Con.Com. & ZBA 04/08/2022 Re-Issued to Con.Com. & ZBA 2/07/2022 | Re-Issued to Conservation Commiss 1/05/2022 | Re-Issued to Conservation Commiss 4 | 11/11/2021 | Re-Issued to ZBA

3 9/01/2021 Re-Issued to ZBA 8/03/2021 Issued to Conservation Commissio 1 | 3/31/2021 | Re-Issued to ZBA REV DATE DESCRIPTION APPLICANT:

CCF QUANNAPOWITT PROPERTY COMPANY, LLC 185 DARTMOUTH STREET BOSTON, MA 02116

200-400 QUANNAPOWITT PARKWAY WAKEFIELD, MA 01880

1623-11 DATE: MARCH 16, 202 N/A DWG. NAME: C-1623-11.dv DESIGNED BY: NCD | CHECKED BY:




civil engineering ◆ land surveying environmental consulting ♦ landscape architecture www.allenmajcr.com 100 COMMERCE WAY WOBURN MA 01888-0118 TEL: (781) 935-6889


FAX: (781) 935-2896 WOBURN, MA ◆ LAKEVILLE, MA ◆ MANCHESTER, M THIS DRAWING HAS BEEN PREPARED IN DIGITAL FORMA CLIENT/CLIENT'S REPRESENTATIVE OR CONSULTANTS MAY B

PROVIDED COPIES OF DRAWINGS AND SPECIFICATIONS FOR HIS/HER INFORMATION AND/OR SPECIFIC USE ON THIS PROJECT. DUE TO THE POTENTIAL THAT THE PROVIDED INFORMATION MAY BE MODIFIED UNINTENTIONALLY OR OTHERWISE, ALLEN & MAJOR ASSOCIATES INC. MAY REMOVE ALL INDICATION OF THE DOCUMENT'S AUTHORSHIP ON THE DIGITAL MEDIA. PRINTED REPRESENTATIONS OF PORTABLE DOCUMENT FORMAT OF THE DRAWINGS AND SPECIFICATIONS ISSUED SHALL BE THE ONLY RECORD COPIES O ALLEN & MAJOR ASSOCIATES, INC.'S WORK PRODUCT.

DRAWING TITLE: **ABBREVIATIONS** Copyright © 2022 Allen & Major Associates, Inc.

BEFORE YOU DIG CALL 811 OR 1-888-DIG-SAFE 1-888-344-7233

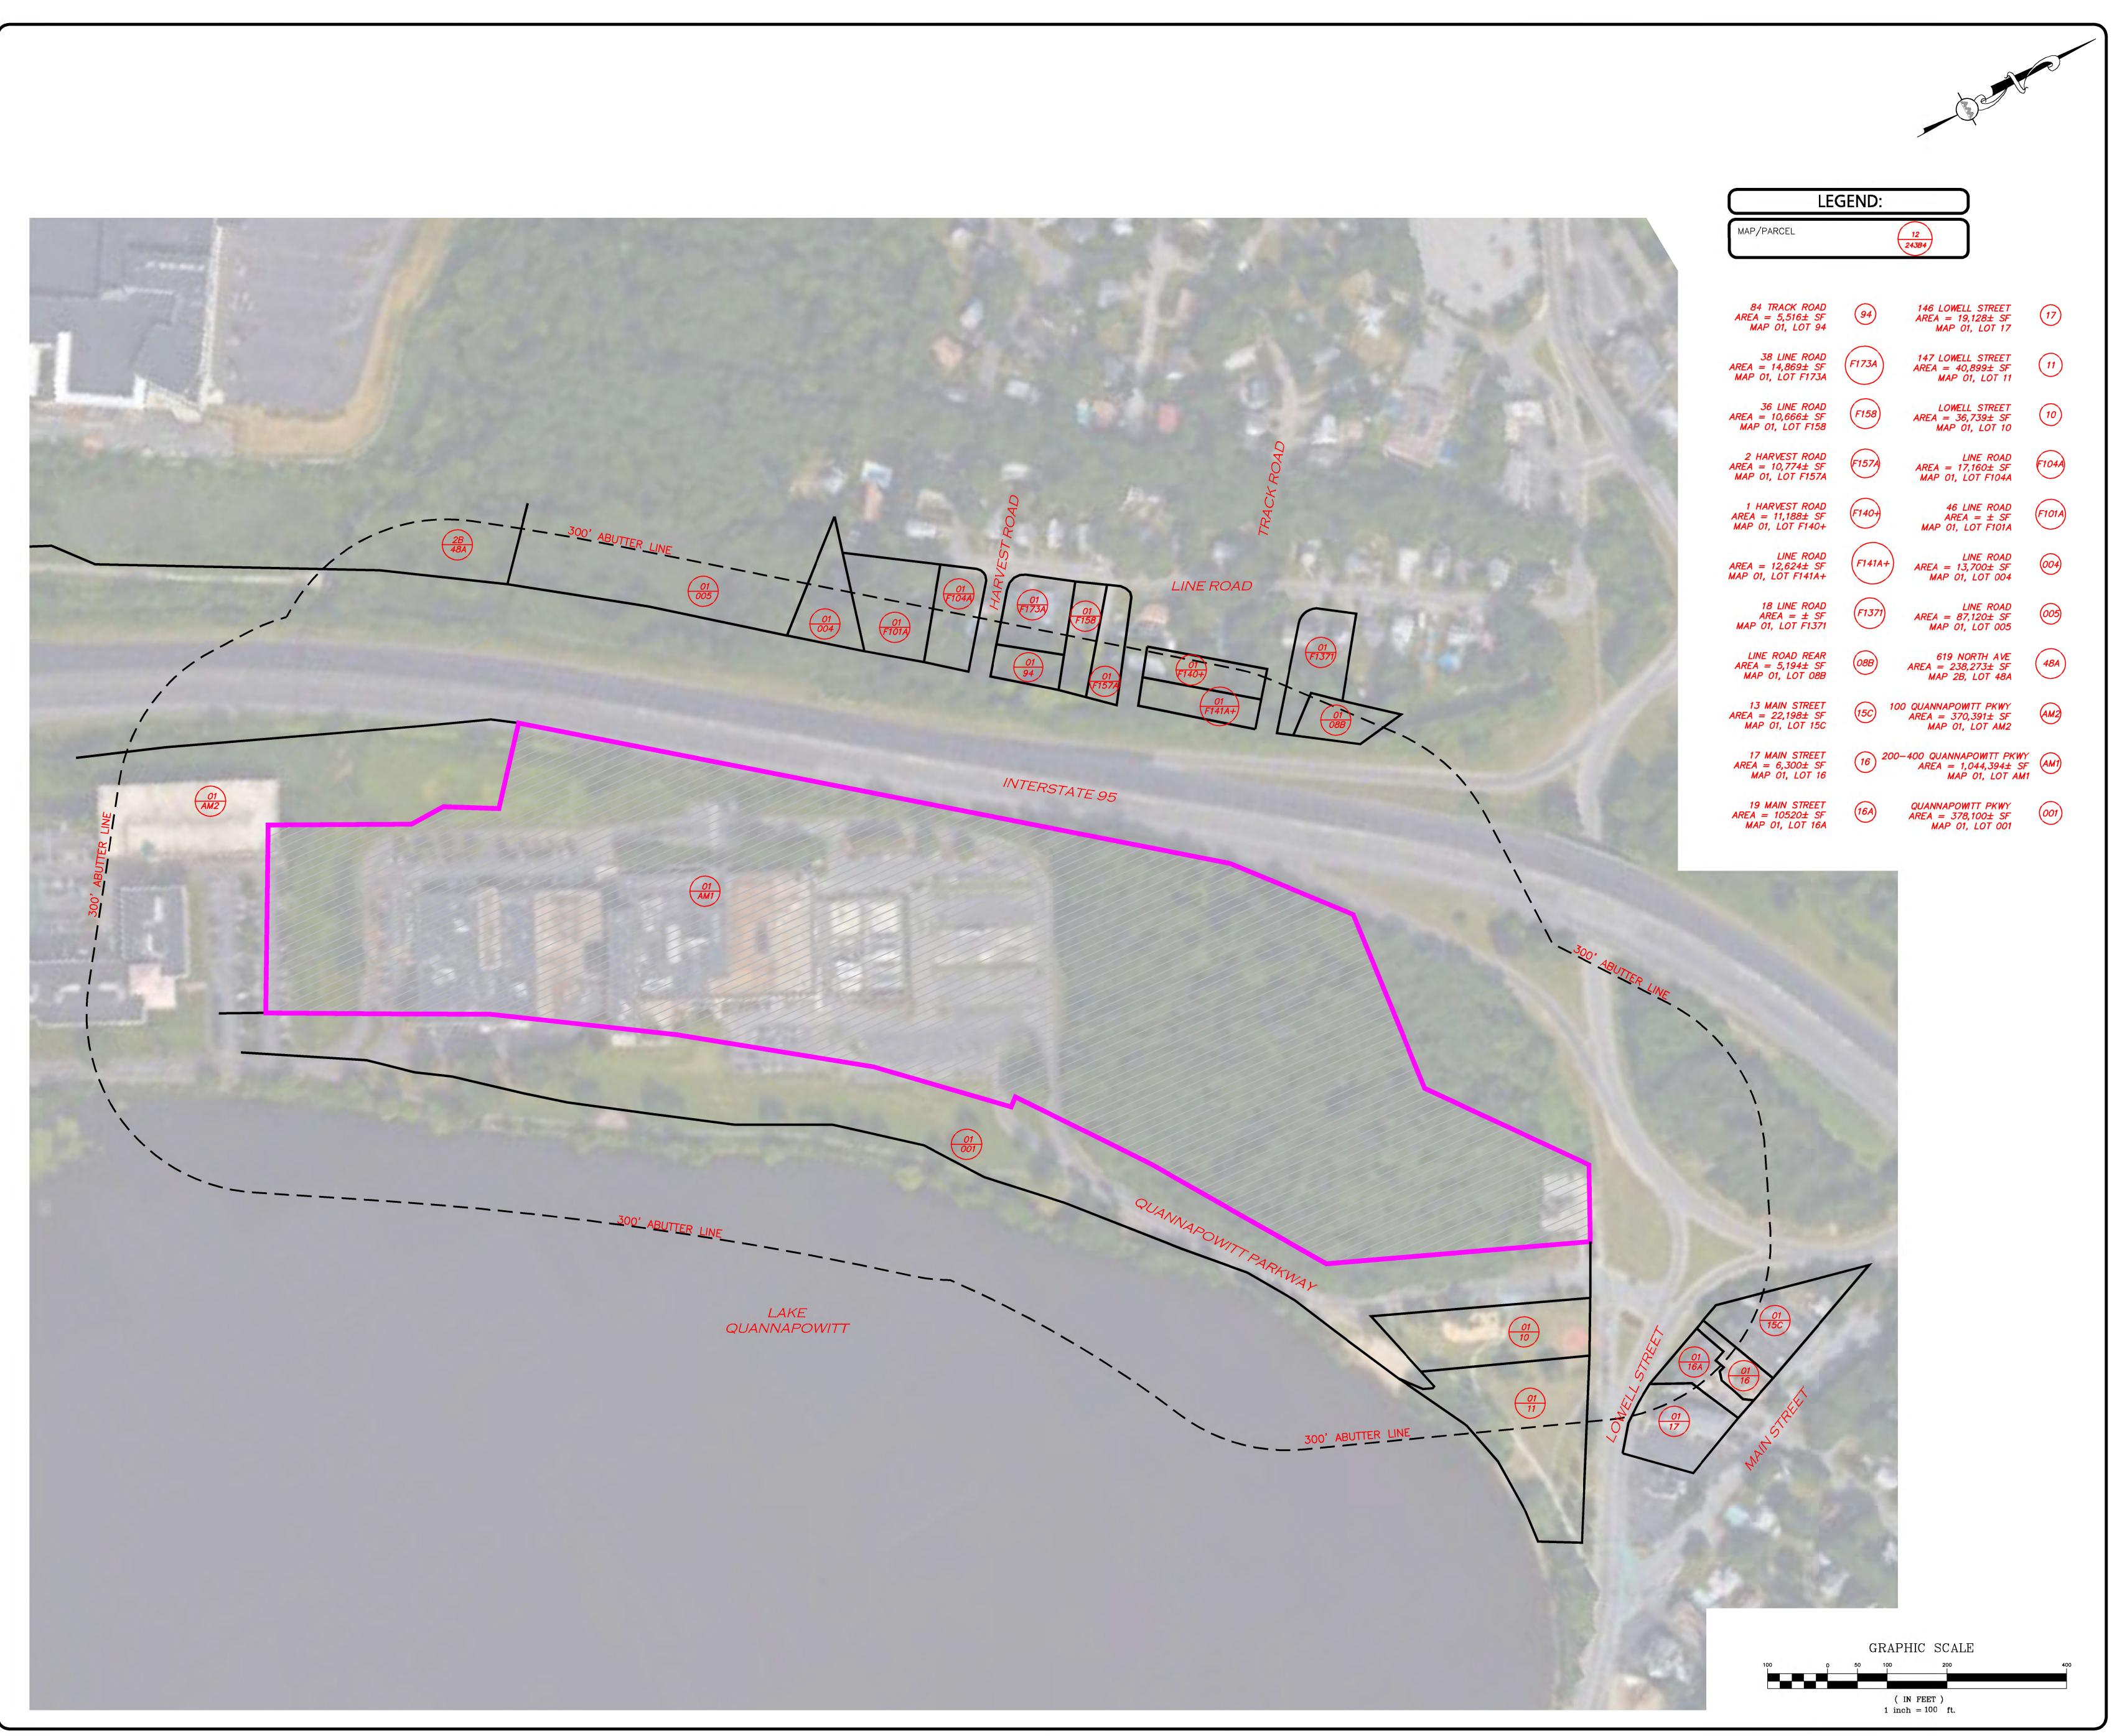

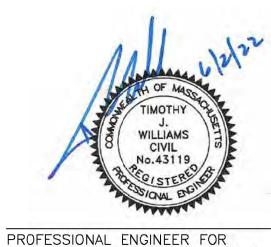

8	06/02/2022	Re-Issued to Con.Com. & ZBA
7	04/08/2022	Re-Issued to Con.Com. & ZBA
6	2/07/2022	Re-Issued to Conservation Commission
5	1/05/2022	Re-Issued to Conservation Commissio
4	11/11/2021	Re-Issued to ZBA
3	9/01/2021	Re-Issued to ZBA
2	8/03/2021	Issued to Conservation Commission
1	3/31/2021	Re-Issued to ZBA
REV	DATE	DESCRIPTION

CCF QUANNAPOWITT PROPERTY COMPANY, LLC 185 DARTMOUTH STREET

BOSTON, MA 02116

200-400 QUANNAPOWITT **PARKWAY** WAKEFIELD, MA 01880

PROJECT NO.	1623-11	DATE:	MARCH	16, 2021
SCALE:	1-100	DWG. NA	AME: C-162	3-11.dwg
DESIGNED BY:	NCD	CHECKE	BY:	WLT
PREPARED BY:				




ASSOCIATES, INC. civil engineering ◆ land surveying

environmental consulting • landscape architecture www.allenmajor.com 100 COMMERCE WAY WOBURN MA 01888-0118 TEL: (781) 935-6889

FAX: (781) 935-2896 WOBURN, MA ◆ LAKEVILLE, MA ◆ MANCHESTER, NE THIS DRAWING HAS BEEN PREPARED IN DIGITAL FORMAT

CLIENT/CLIENT'S REPRESENTATIVE OR CONSULTANTS MAY BE PROVIDED COPIES OF DRAWINGS AND SPECIFICATIONS FOR HIS/HER INFORMATION AND/OR SPECIFIC USE ON THIS PROJECT. DUE TO THE POTENTIAL THAT THE PROVIDED INFORMATION MAY BE MODIFIED UNINTENTIONALLY OR OTHERWISE, ALLEN & MAJOR ASSOCIATES, INC. MAY REMOVE ALL INDICATION OF THE DOCUMENT'S AUTHORSHIP ON THE DIGITAL MEDIA. PRINTED REPRESENTATIONS OR PORTABLE DOCUMENT FORMAT OF THE DRAWINGS AND SPECIFICATIONS OF ALLERY AND ASSOCIATE IN ISLANDER OF THE DRAWINGS OF ALLERY AND ASSOCIATE IN ISLANDER OF THE DRAWINGS OF ALLERY AND ASSOCIATE IN ISLANDER OF THE DRAWINGS OF THE INCIDENT OF THE DRAWINGS OF THE INCIDENT OF THE DRAWINGS OF THE INCIDENT OF THE IN ALLEN & MAJOR ASSOCIATES, INC.'S WORK PRODUCT.

DRAWING TITLE: **CONTEXT PLAN**

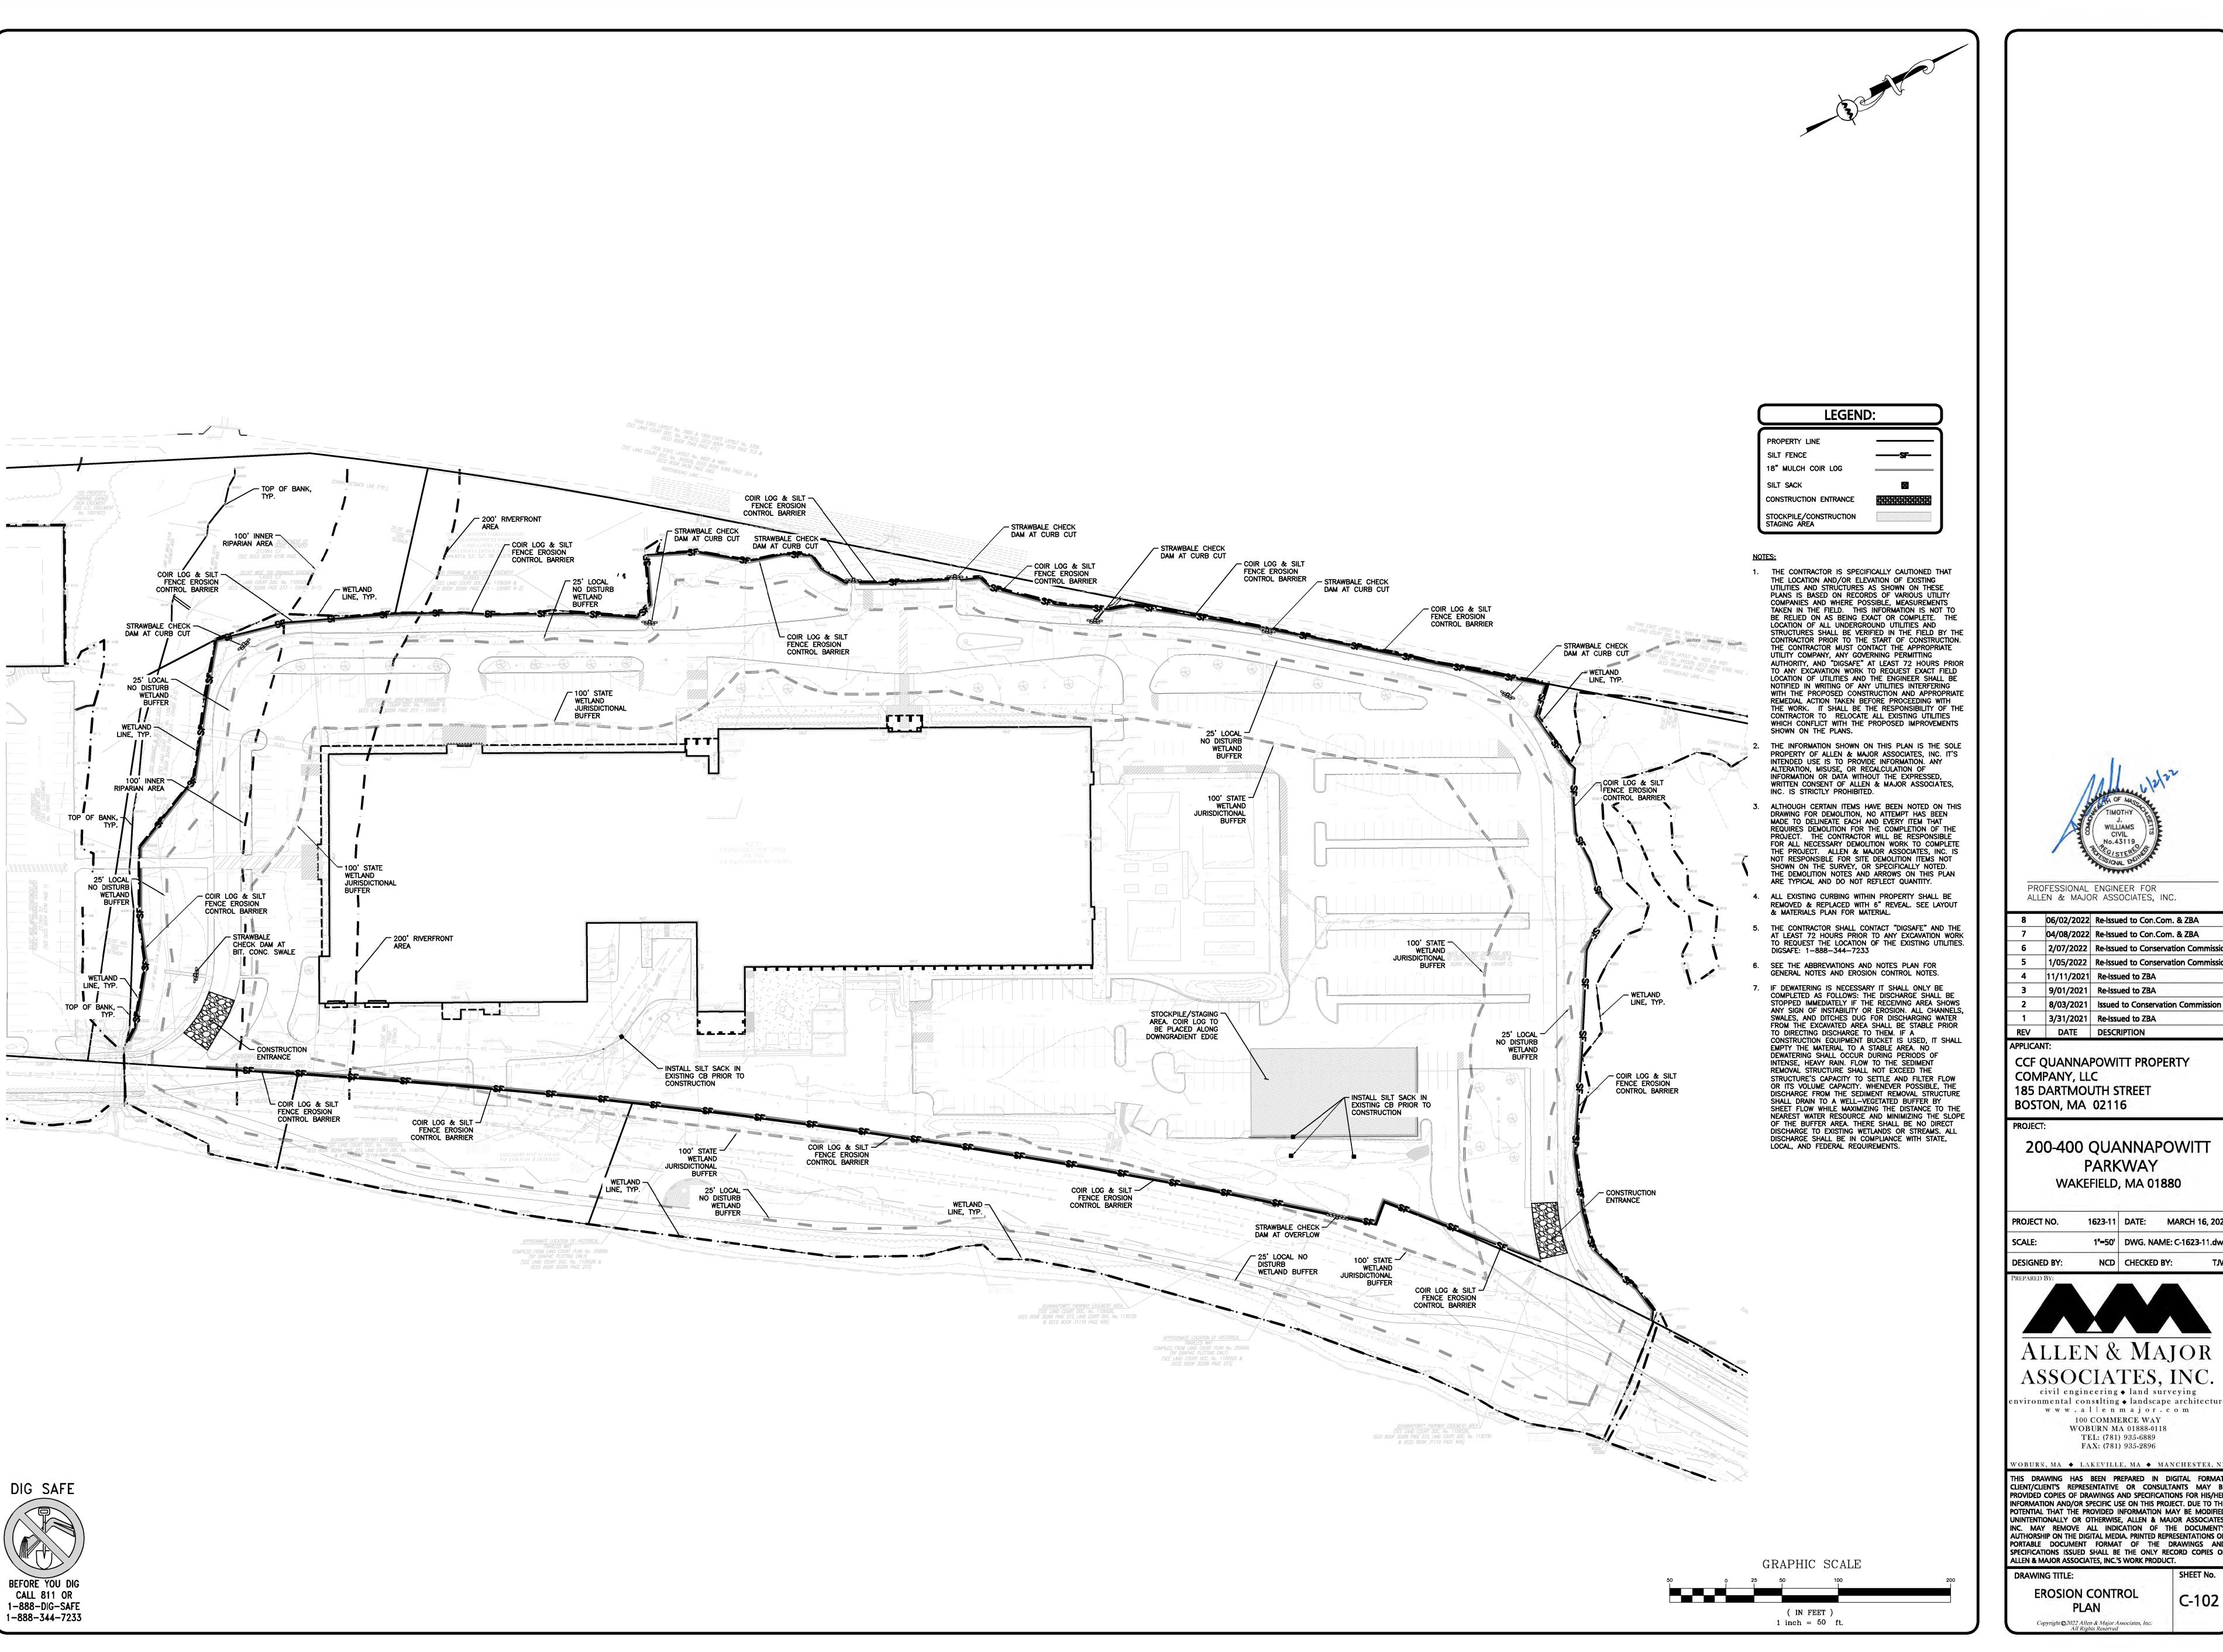



8 06/02/2022 Re-Issued to Con.Com. & ZBA 04/08/2022 Re-Issued to Con.Com. & ZBA 6 2/07/2022 Re-Issued to Conservation Commission 1/05/2022 | Re-Issued to Conservation Commission 4 | 11/11/2021 | Re-Issued to ZBA 9/01/2021 Re-Issued to ZBA 8/03/2021 Issued to Conservation Commission 3/31/2021 Re-Issued to ZBA

APPLICANT: CCF QUANNAPOWITT PROPERTY COMPANY, LLC **185 DARTMOUTH STREET** BOSTON, MA 02116

REV DATE DESCRIPTION

200-400 QUANNAPOWITT **PARKWAY** WAKEFIELD, MA 01880

1623-11 DATE: MARCH 16, 2021

SCALE: 1"=50' DWG. NAME: C-1623-11.dwg **DESIGNED BY:** NCD | CHECKED BY:





ASSOCIATES, INC. civil engineering ◆ land surveying

nvironmental consulting ♦ landscape architecture www.allenmajor.com 100 COMMERCE WAY WOBURN MA 01888-0118 TEL: (781) 935-6889 FAX: (781) 935-2896

THIS DRAWING HAS BEEN PREPARED IN DIGITAL FORMAT. CLIENT/CLIENT'S REPRESENTATIVE OR CONSULTANTS MAY BE PROVIDED COPIES OF DRAWINGS AND SPECIFICATIONS FOR HIS/HER INFORMATION AND/OR SPECIFIC USE ON THIS PROJECT. DUE TO THE POTENTIAL THAT THE PROVIDED INFORMATION MAY BE MODIFIED UNINTENTIONALLY OR OTHERWISE, ALLEN & MAJOR ASSOCIATES, INC. MAY REMOVE ALL INDICATION OF THE DOCUMENT'S AUTHORSHIP ON THE DIGITAL MEDIA. PRINTED REPRESENTATIONS OR PORTABLE DOCUMENT FORMAT OF THE DRAWINGS AND SPECIFICATIONS ISSUED SHALL BE THE ONLY RECORD COPIES OF ALLEN & MAJOR ASSOCIATES, INC.'S WORK PRODUCT.

DRAWING TITLE: **EROSION CONTROL** C-102

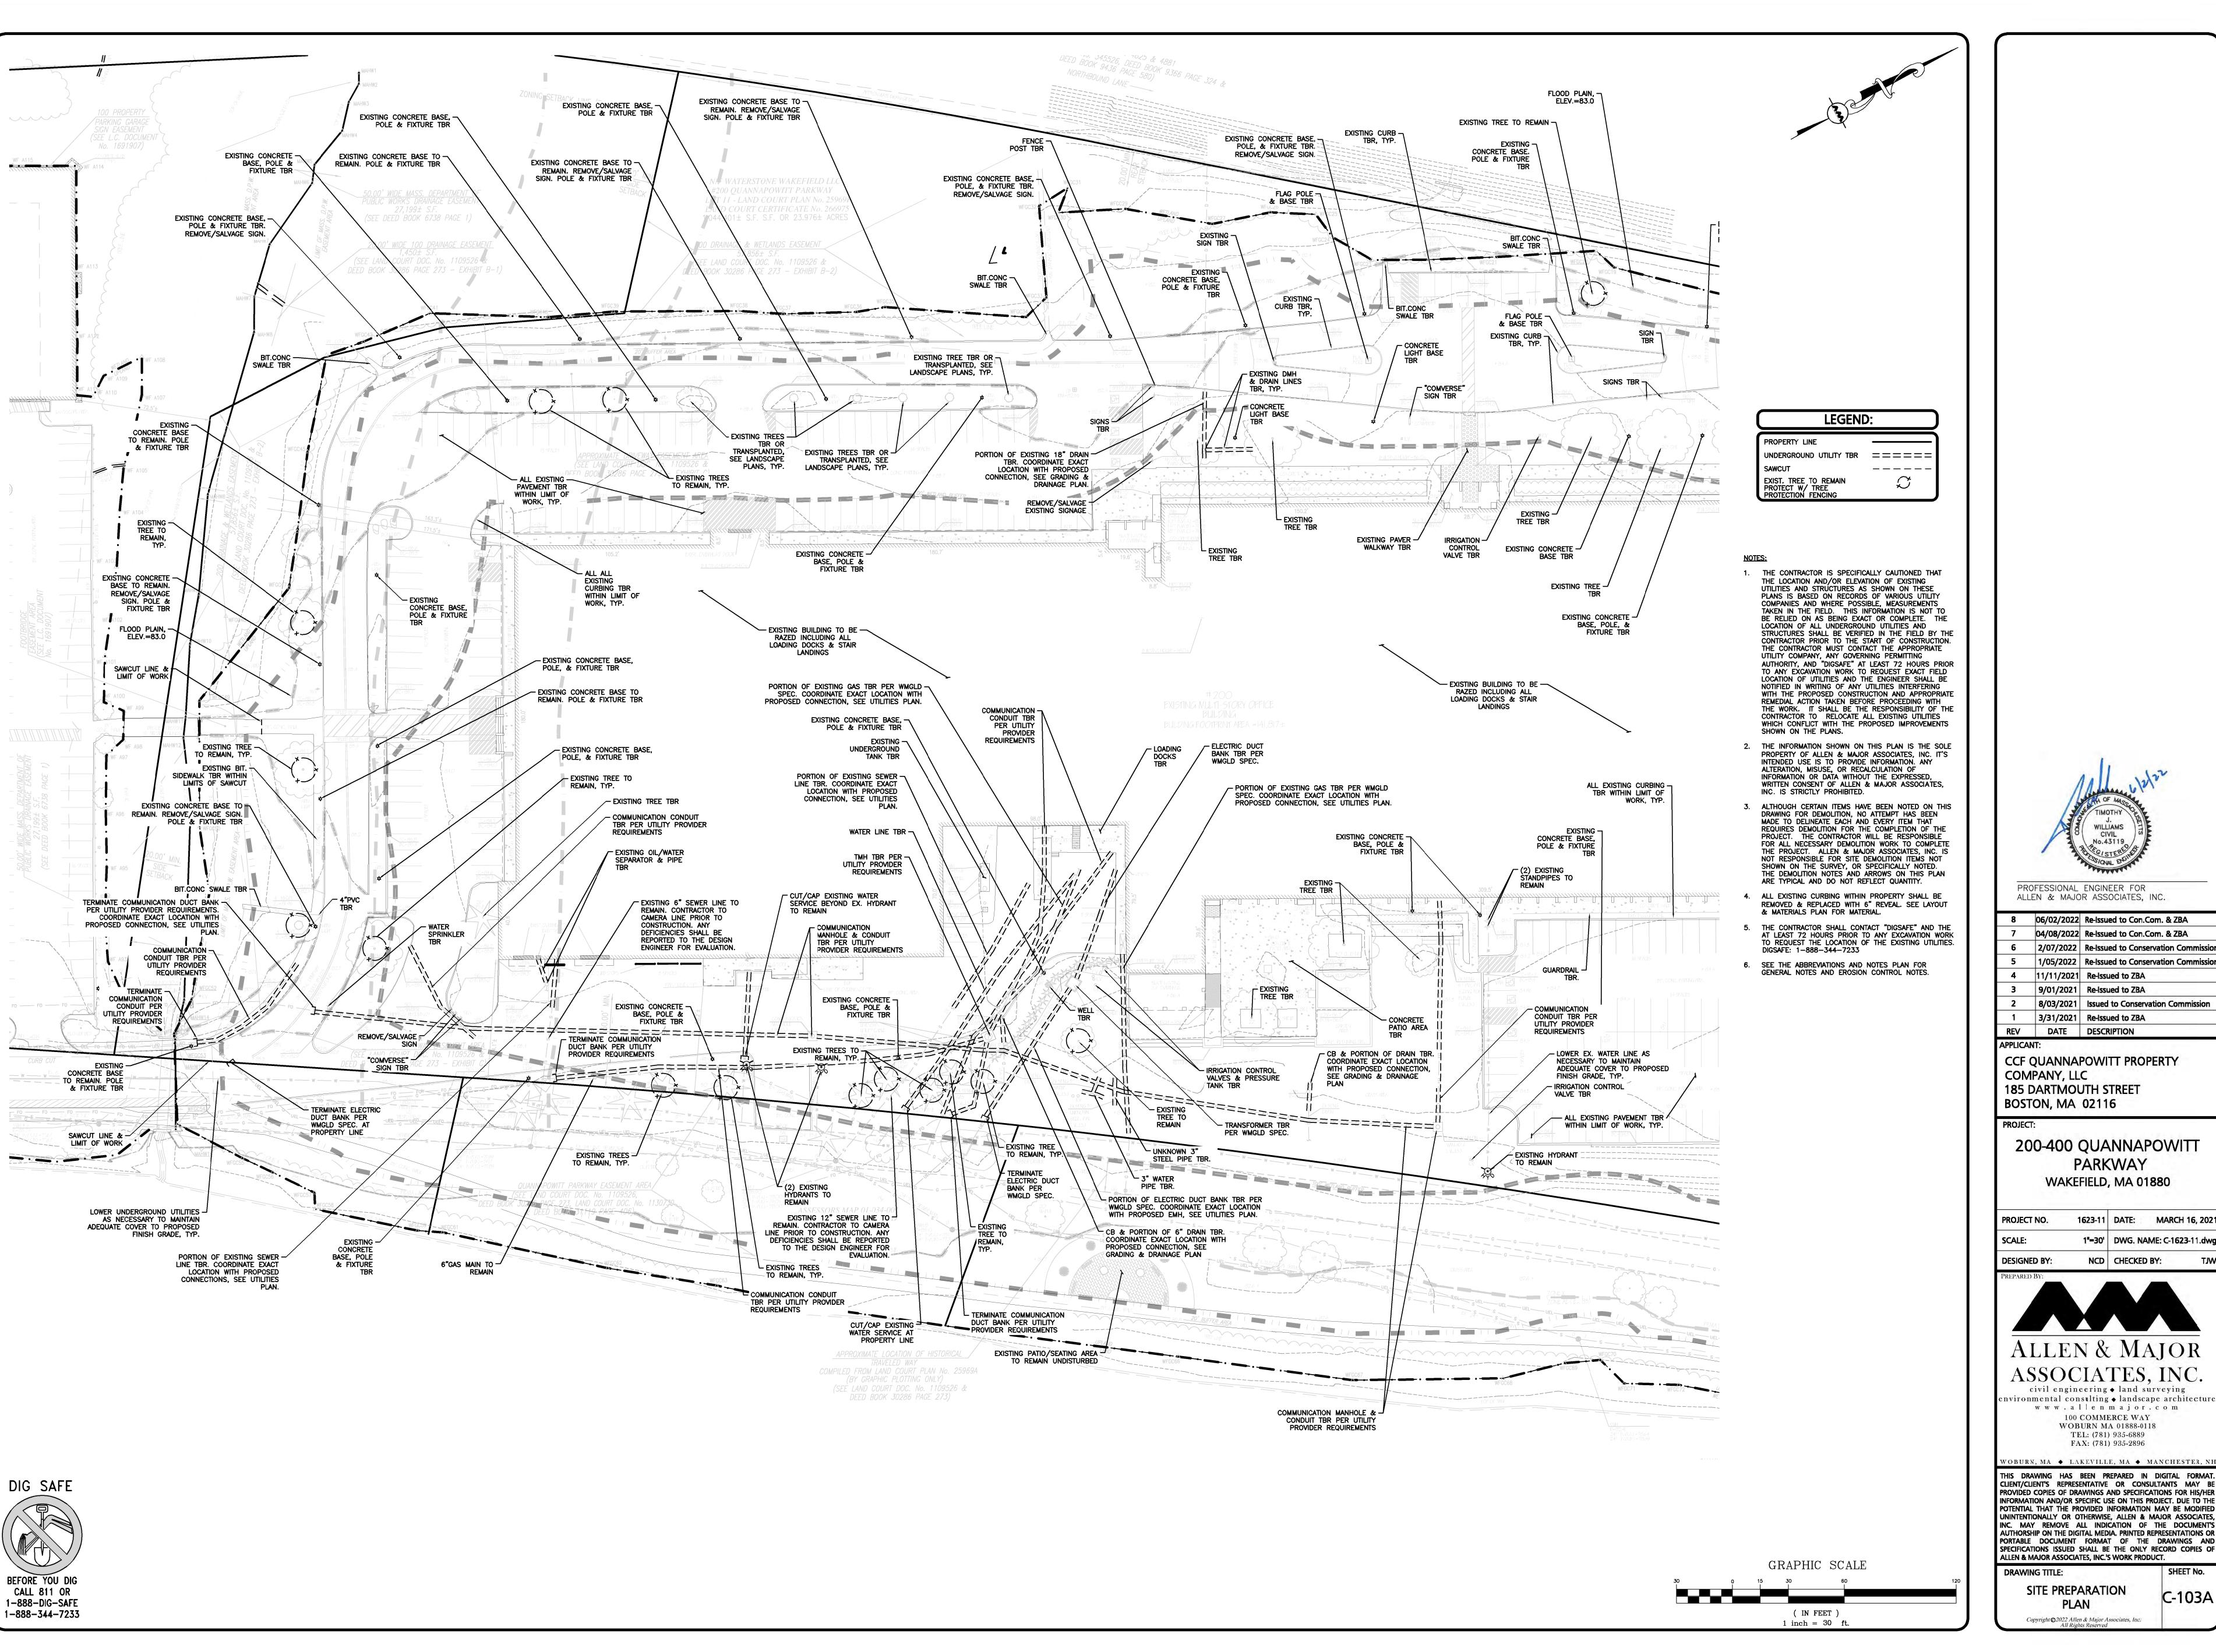

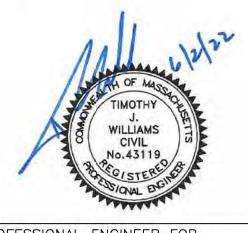

8 06/02/2022 Re-Issued to Con.Com. & ZBA 04/08/2022 Re-Issued to Con.Com. & ZBA 2/07/2022 | Re-Issued to Conservation Commission 1/05/2022 | Re-Issued to Conservation Commission 4 | 11/11/2021 | Re-Issued to ZBA 9/01/2021 | Re-Issued to ZBA 8/03/2021 Issued to Conservation Commission 3/31/2021 Re-Issued to ZBA DATE DESCRIPTION REV

CCF QUANNAPOWITT PROPERTY COMPANY, LLC **185 DARTMOUTH STREET** BOSTON, MA 02116

200-400 QUANNAPOWITT **PARKWAY** WAKEFIELD, MA 01880

PROJECT NO.

1623-11 DATE: MARCH 16, 2021

SCALE: 1"=30' DWG. NAME: C-1623-11.dwg **DESIGNED BY:** NCD | CHECKED BY:



ASSOCIATES, INC. civil engineering ◆ land surveying

nvironmental consulting ♦ landscape architecture www.allenmajor.com 100 COMMERCE WAY WOBURN MA 01888-0118 TEL: (781) 935-6889

FAX: (781) 935-2896


WOBURN, MA ◆ LAKEVILLE, MA ◆ MANCHESTER, N THIS DRAWING HAS BEEN PREPARED IN DIGITAL FORMAT. CLIENT/CLIENT'S REPRESENTATIVE OR CONSULTANTS MAY BE PROVIDED COPIES OF DRAWINGS AND SPECIFICATIONS FOR HIS/HER INFORMATION AND/OR SPECIFIC USE ON THIS PROJECT. DUE TO THE POTENTIAL THAT THE PROVIDED INFORMATION MAY BE MODIFIED UNINTENTIONALLY OR OTHERWISE, ALLEN & MAJOR ASSOCIATES, INC. MAY REMOVE ALL INDICATION OF THE DOCUMENT'S AUTHORSHIP ON THE DIGITAL MEDIA. PRINTED REPRESENTATIONS OR


SPECIFICATIONS ISSUED SHALL BE THE ONLY RECORD COPIES OF ALLEN & MAJOR ASSOCIATES, INC.'S WORK PRODUCT. DRAWING TITLE: SHEET No.

C-103A

Copyright ©2022 Allen & Major Associates, Inc. All Rights Reserved

SITE PREPARATION

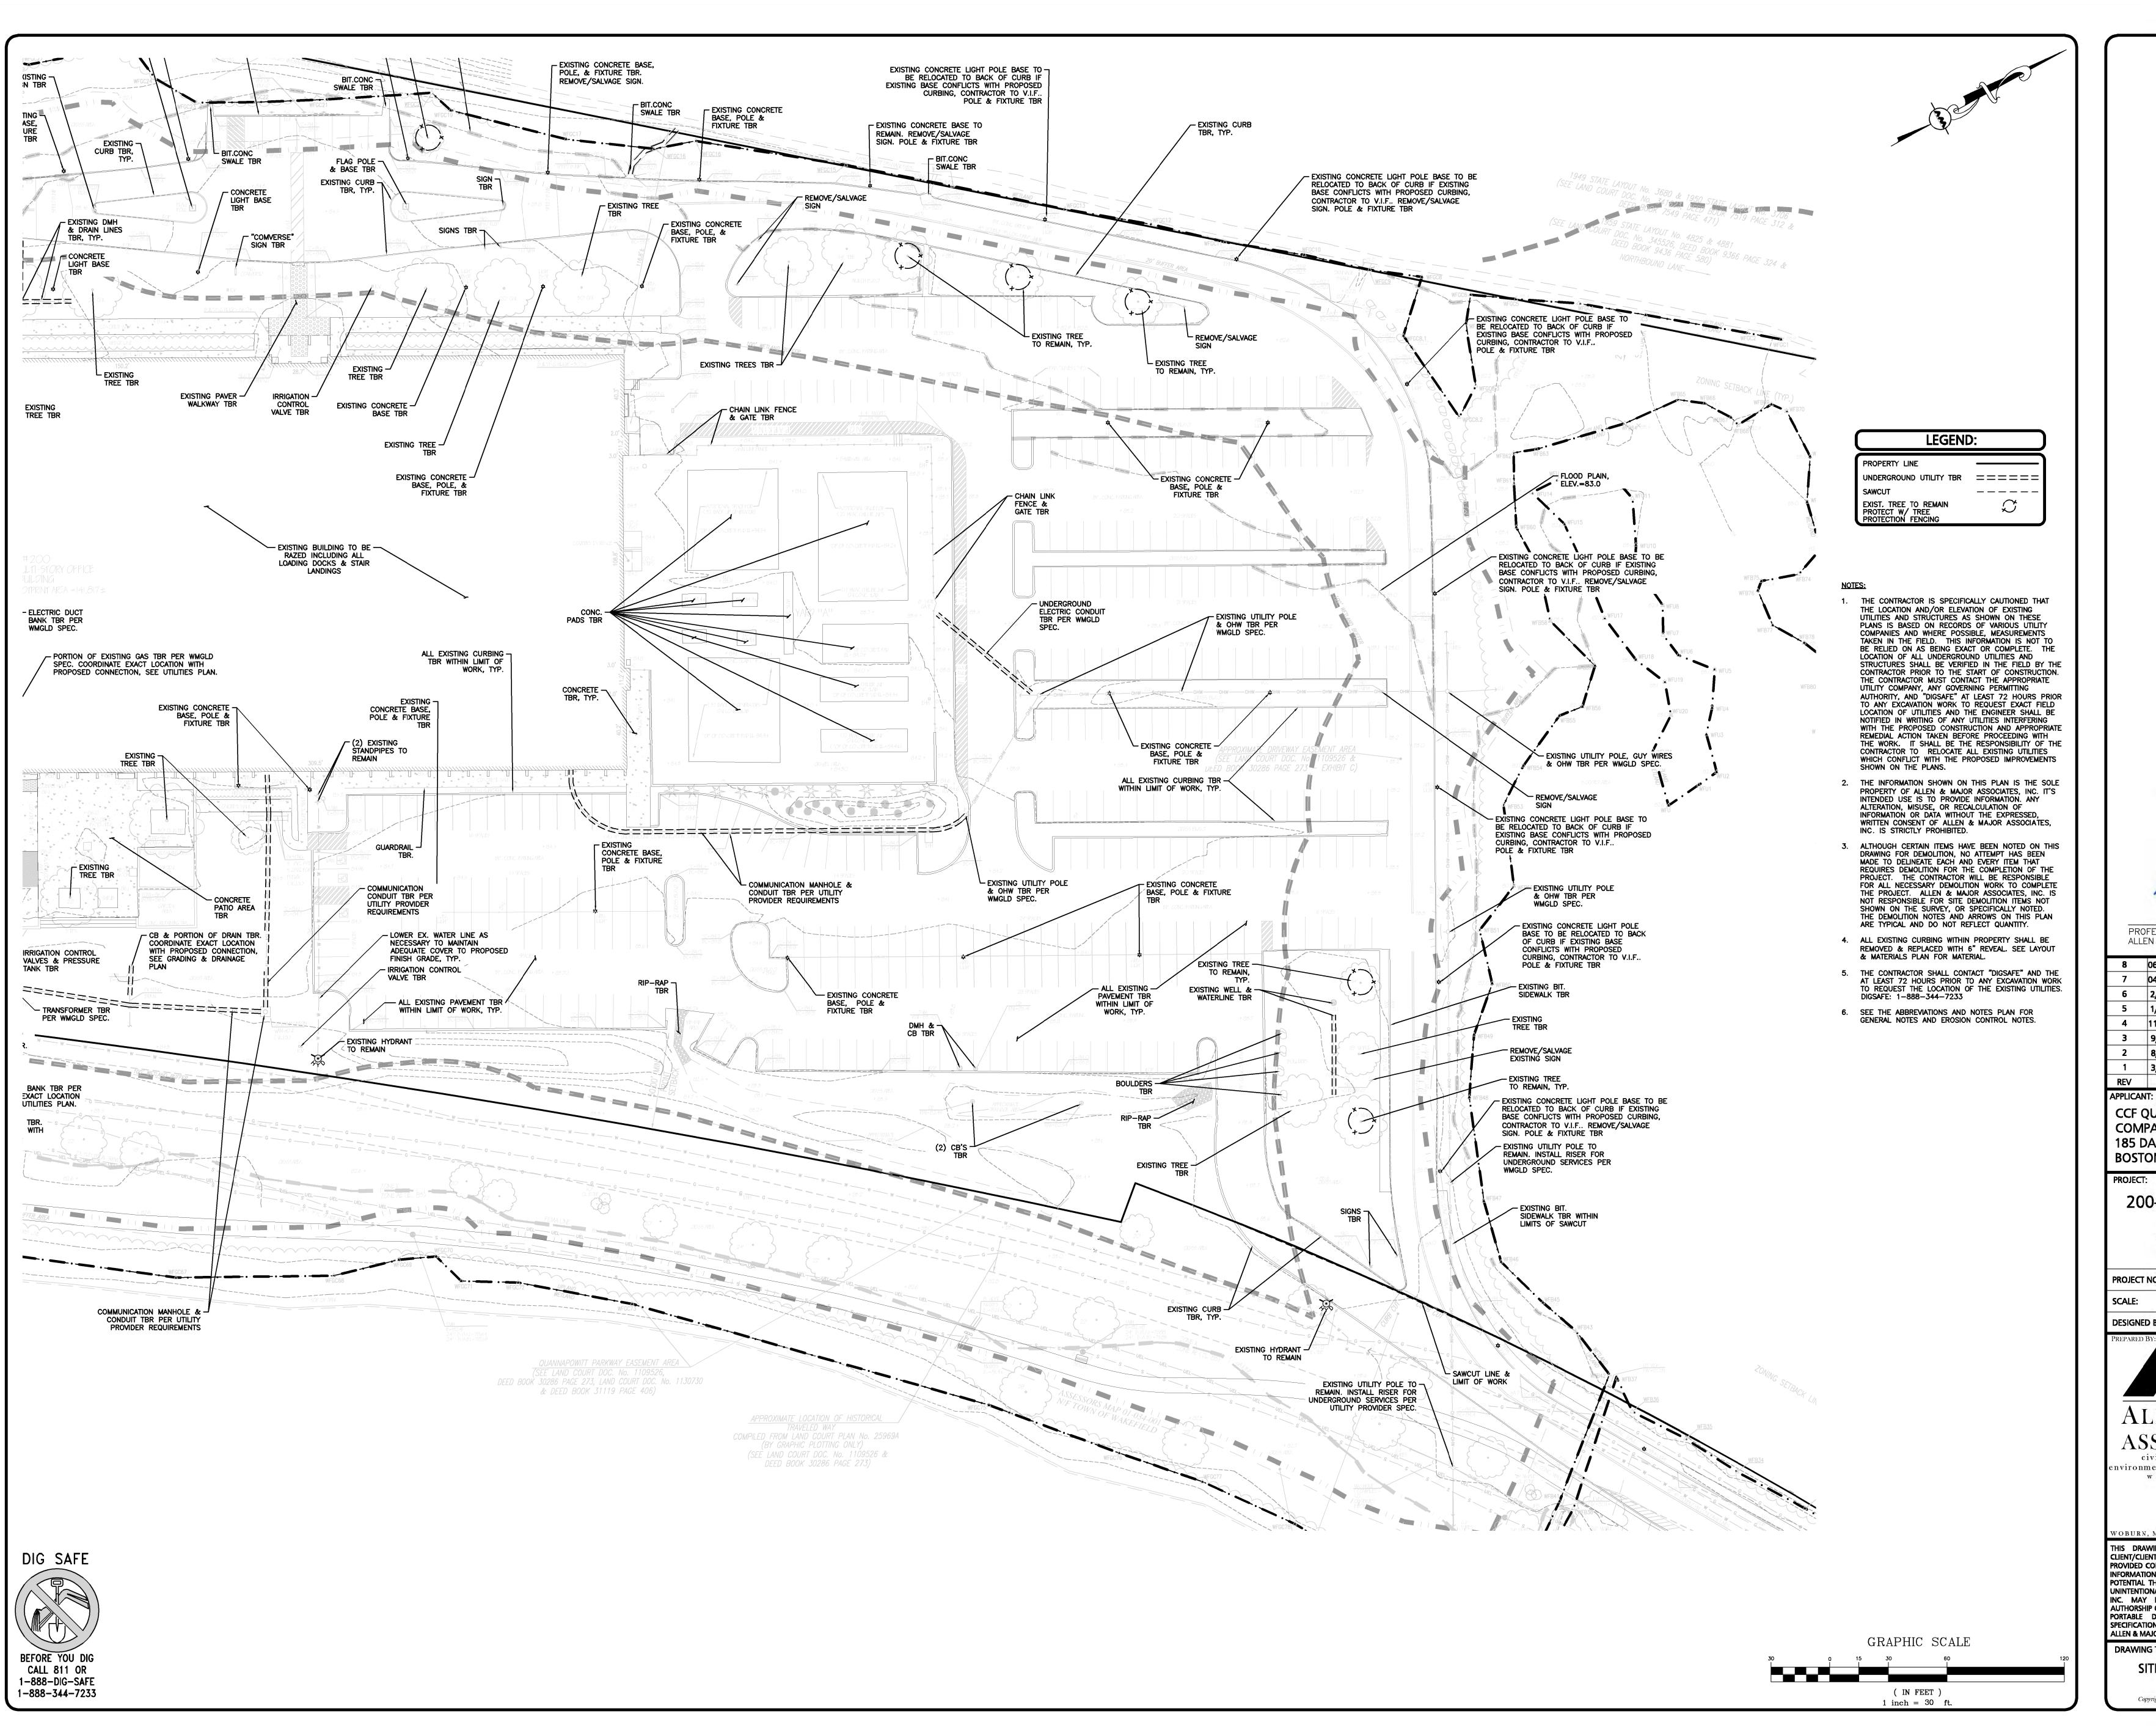

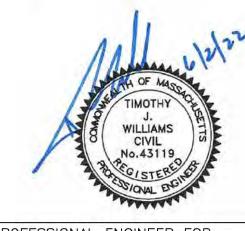

8 06/02/2022 Re-Issued to Con.Com. & ZBA

04/08/2022 Re-Issued to Con.Com. & ZBA 2/07/2022 | Re-Issued to Conservation Commission 1/05/2022 | Re-Issued to Conservation Commission 4 | 11/11/2021 | Re-Issued to ZBA 3 9/01/2021 Re-Issued to ZBA 8/03/2021 Issued to Conservation Commission 3/31/2021 Re-Issued to ZBA REV DATE DESCRIPTION

CCF QUANNAPOWITT PROPERTY COMPANY, LLC **185 DARTMOUTH STREET** BOSTON, MA 02116

200-400 QUANNAPOWITT **PARKWAY** WAKEFIELD, MA 01880

1623-11 DATE: MARCH 16, 2021 **SCALE:**

1"=30' DWG. NAME: C-1623-11.dwg

DESIGNED BY: NCD | CHECKED BY:



ASSOCIATES, INC. civil engineering ◆ land surveying


vironmental consulting • landscape architecture www.allenmajor.com 100 COMMERCE WAY WOBURN MA 01888-0118 TEL: (781) 935-6889


FAX: (781) 935-2896

WOBURN, MA ◆ LAKEVILLE, MA ◆ MANCHESTER, N

THIS DRAWING HAS BEEN PREPARED IN DIGITAL FORMAT. CLIENT/CLIENT'S REPRESENTATIVE OR CONSULTANTS MAY BE PROVIDED COPIES OF DRAWINGS AND SPECIFICATIONS FOR HIS/HER INFORMATION AND/OR SPECIFIC USE ON THIS PROJECT. DUE TO THE POTENTIAL THAT THE PROVIDED INFORMATION MAY BE MODIFIED UNINTENTIONALLY OR OTHERWISE, ALLEN & MAJOR ASSOCIATES, INC. MAY REMOVE ALL INDICATION OF THE DOCUMENT'S AUTHORSHIP ON THE DIGITAL MEDIA. PRINTED REPRESENTATIONS OR PORTABLE DOCUMENT FORMAT OF THE DRAWINGS AND SPECIFICATIONS ISSUED SHALL BE THE ONLY RECORD COPIES OF ALLEN & MAJOR ASSOCIATES, INC.'S WORK PRODUCT.

DRAWING TITLE: SITE PREPARATION

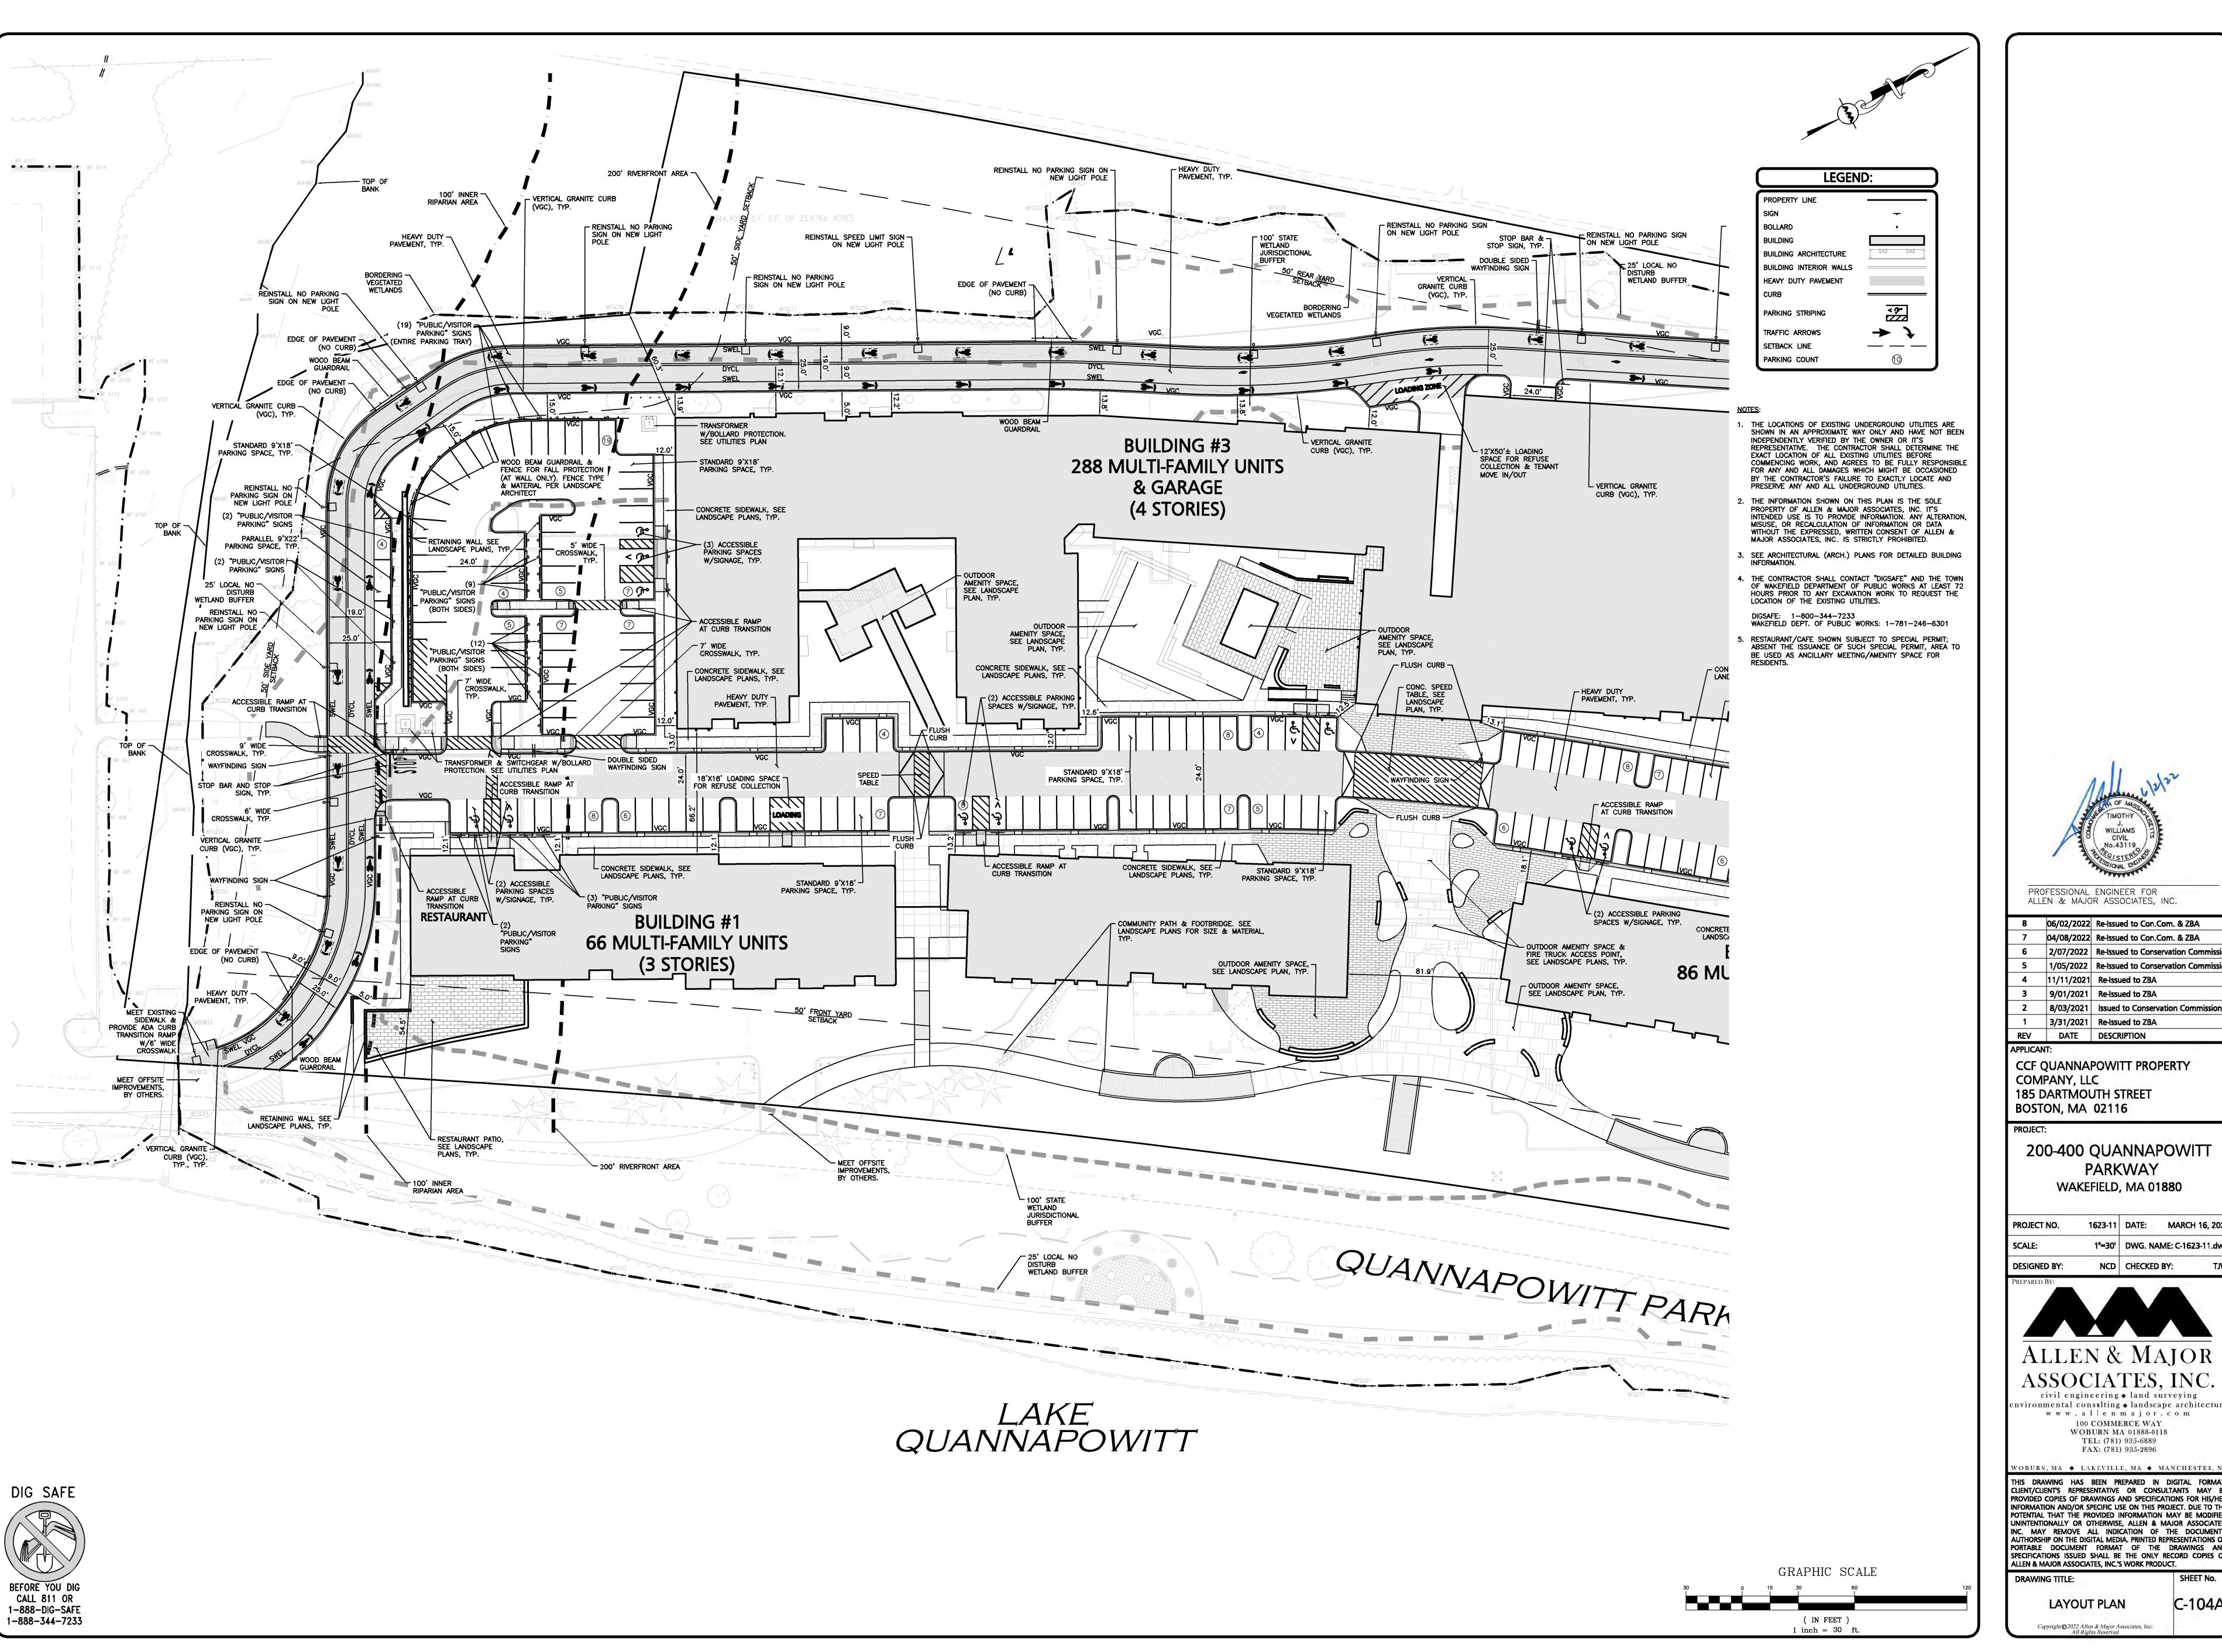

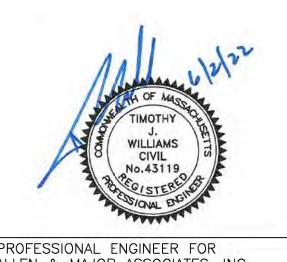

06/02/2022 Re-Issued to Con.Com. & ZBA 04/08/2022 Re-Issued to Con.Com. & ZBA 2/07/2022 Re-Issued to Conservation Commis 1/05/2022 | Re-Issued to Conservation Commiss 11/11/2021 Re-Issued to ZBA 9/01/2021 Re-Issued to ZBA 8/03/2021 Issued to Conservation Commissio 3/31/2021 Re-Issued to ZBA DATE DESCRIPTION

CCF QUANNAPOWITT PROPERTY COMPANY, LLC **185 DARTMOUTH STREET** BOSTON, MA 02116

200-400 QUANNAPOWITT **PARKWAY** WAKEFIELD, MA 01880

1623-11 DATE: MARCH 16, 202

1"=30' DWG. NAME: C-1623-11.dw

DESIGNED BY: NCD CHECKED BY:




ASSOCIATES, INC. civil engineering ◆ land surveying


nvironmental consulting ♦ landscape architecture www.allenmajor.com 100 COMMERCE WAY WOBURN MA 01888-0118 TEL: (781) 935-6889 FAX: (781) 935-2896

THIS DRAWING HAS BEEN PREPARED IN DIGITAL FORMAT CLIENT/CLIENT'S REPRESENTATIVE OR CONSULTANTS MAY BE PROVIDED COPIES OF DRAWINGS AND SPECIFICATIONS FOR HIS/HER INFORMATION AND/OR SPECIFIC USE ON THIS PROJECT. DUE TO THE POTENTIAL THAT THE PROVIDED INFORMATION MAY BE MODIFIED UNINTENTIONALLY OR OTHERWISE, ALLEN & MAJOR ASSOCIATES, INC. MAY REMOVE ALL INDICATION OF THE DOCUMENT'S AUTHORSHIP ON THE DIGITAL MEDIA. PRINTED REPRESENTATIONS OR PORTABLE DOCUMENT FORMAT OF THE DRAWINGS AND SPECIFICATIONS ISSUED SHALL BE THE ONLY RECORD COPIES OF ALLEN & MAJOR ASSOCIATES, INC.'S WORK PRODUCT.

DRAWING TITLE:

C-104A LAYOUT PLAN

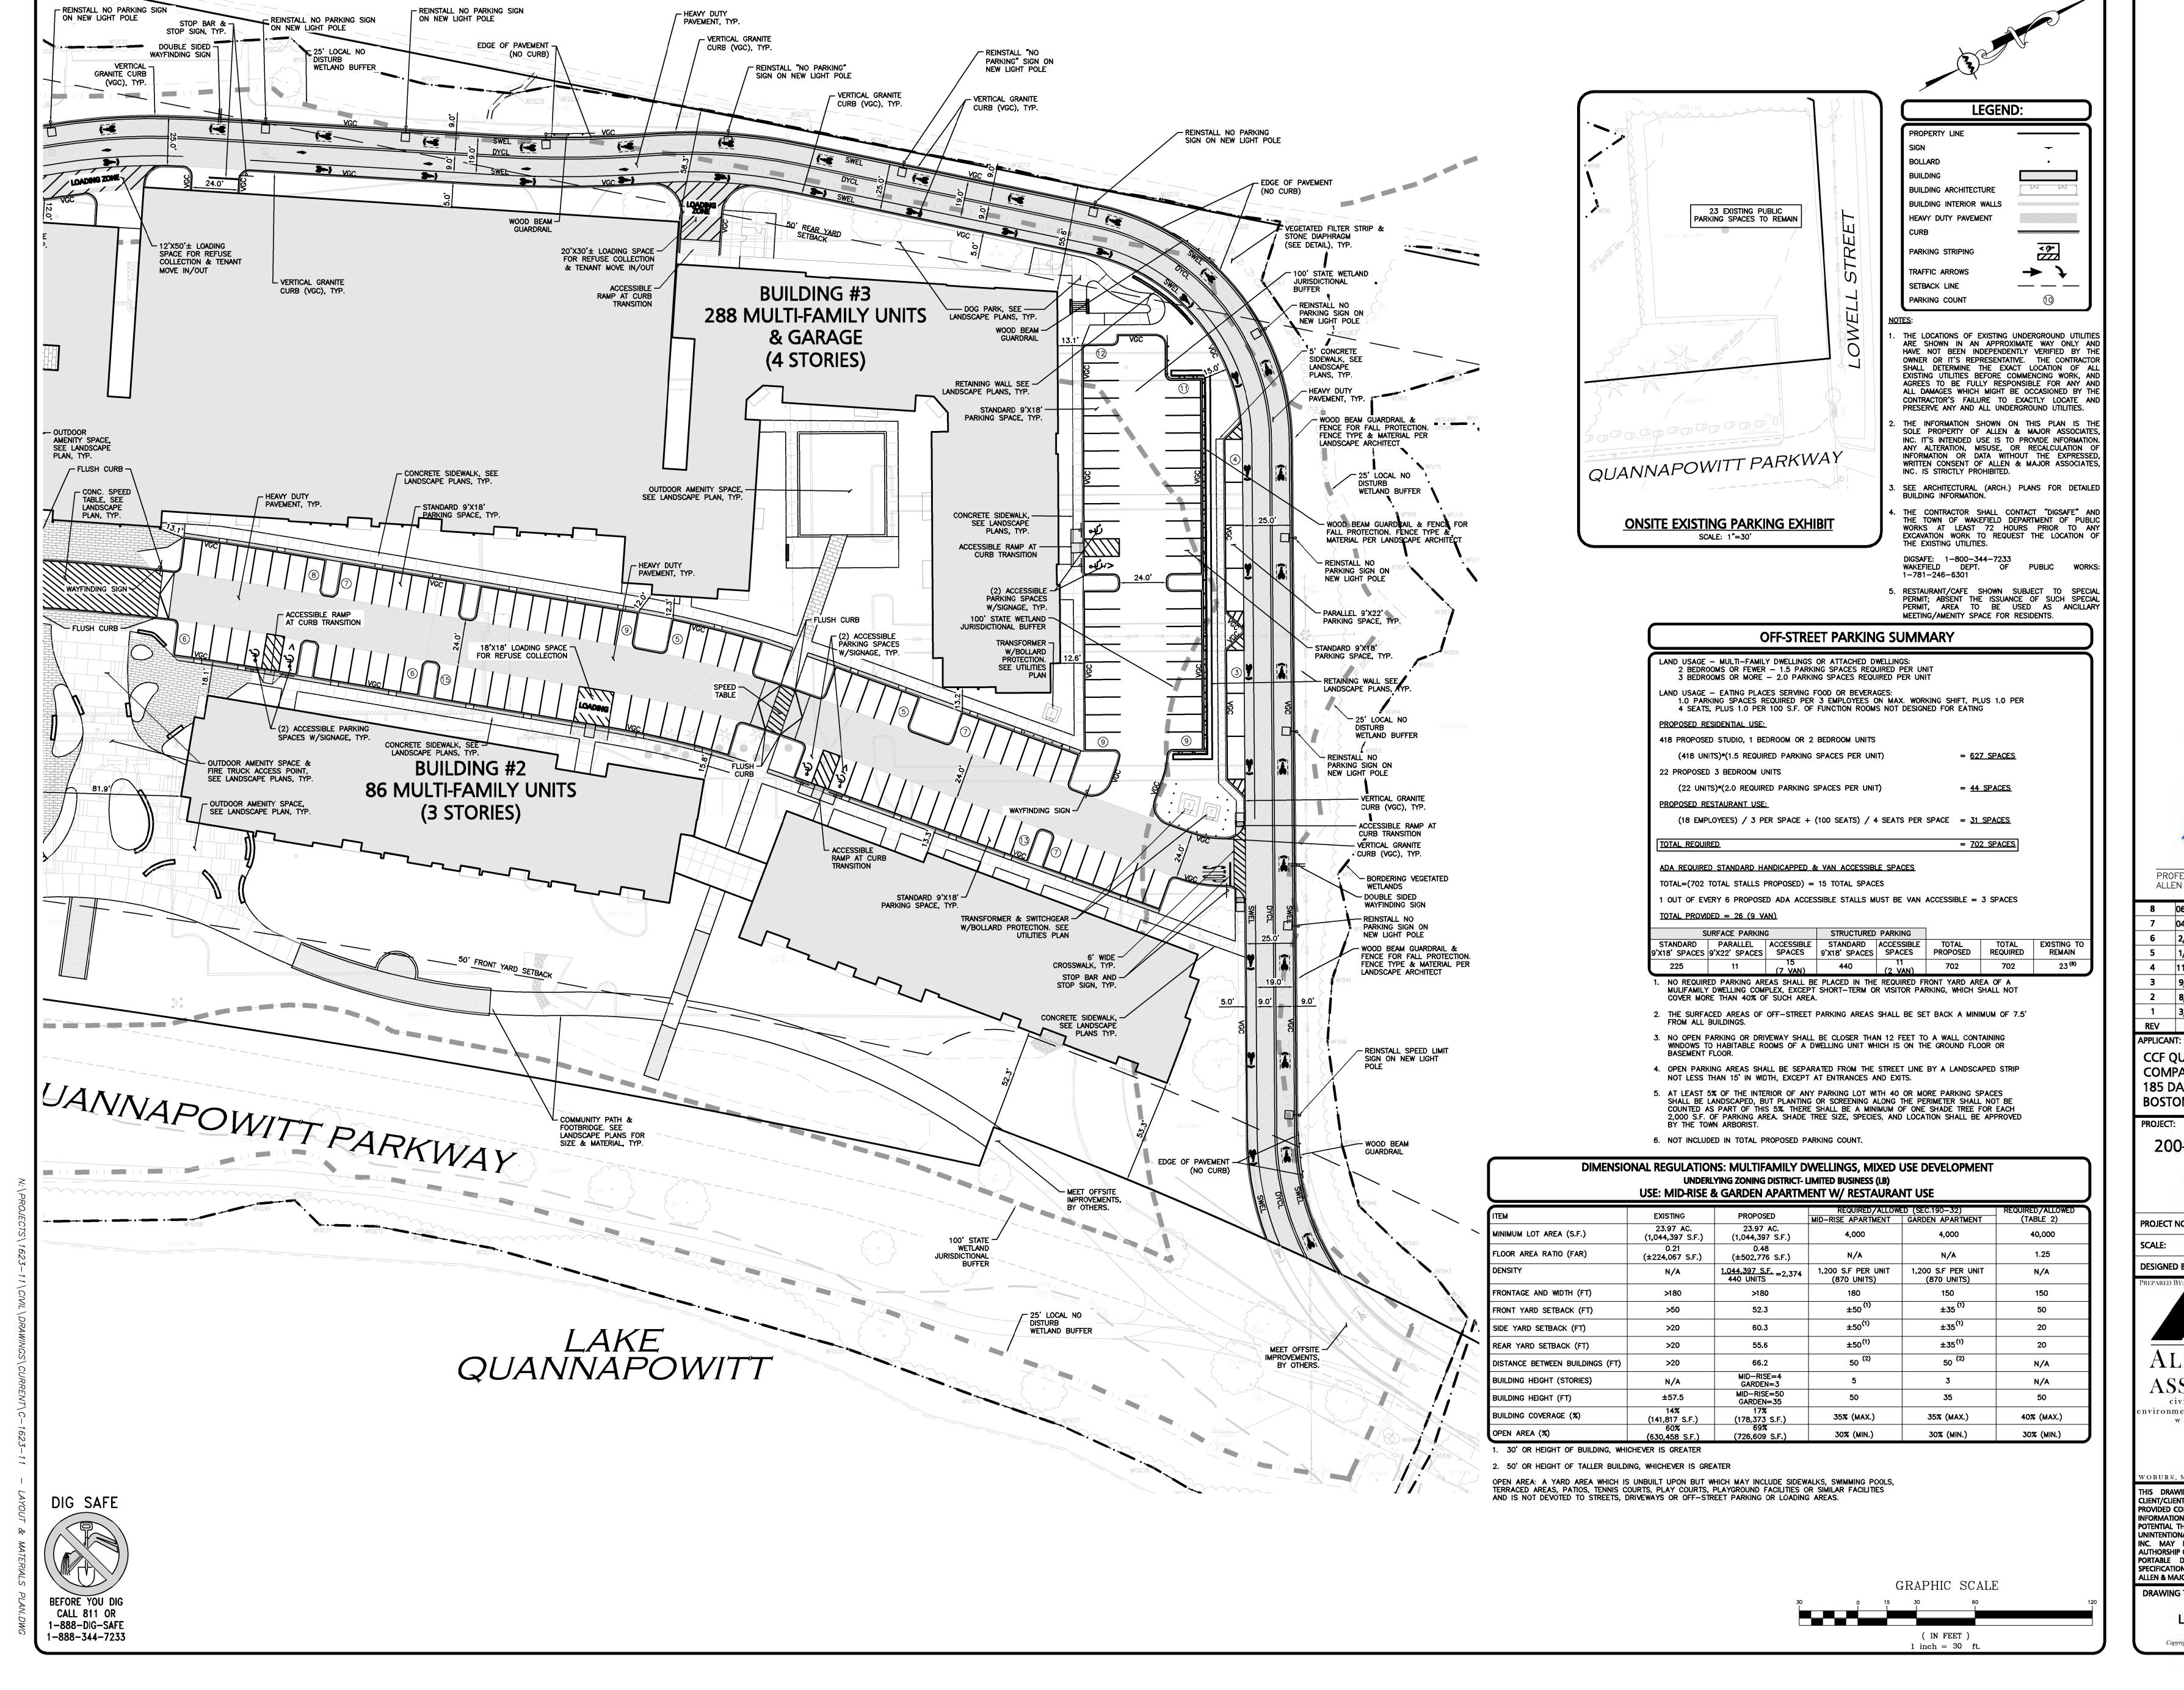

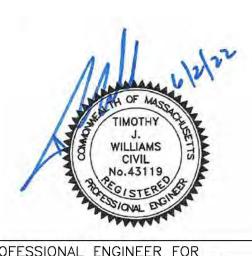

06/02/2022 Re-Issued to Con.Com. & ZBA 04/08/2022 Re-Issued to Con.Com. & ZBA 2/07/2022 | Re-Issued to Conservation Commiss 1/05/2022 | Re-Issued to Conservation Commiss 4 | 11/11/2021 | Re-Issued to ZBA 9/01/2021 Re-Issued to ZBA 8/03/2021 Issued to Conservation Commission 3/31/2021 Re-Issued to ZBA DATE DESCRIPTION

CCF QUANNAPOWITT PROPERTY COMPANY, LLC **185 DARTMOUTH STREET** BOSTON, MA 02116

200-400 QUANNAPOWITT **PARKWAY** WAKEFIELD, MA 01880

1623-11 DATE: MARCH 16, 202 1"=30' DWG. NAME: C-1623-11.dw **DESIGNED BY:** NCD | CHECKED BY:



ASSOCIATES, INC. civil engineering ◆ land surveying


ivironmental consulting • landscape architecture www.allenmajor.com 100 COMMERCE WAY WOBURN MA 01888-0118 TEL: (781) 935-6889

FAX: (781) 935-2896 WOBURN, MA ♦ LAKEVILLE, MA ♦ MANCHESTER, N

THIS DRAWING HAS BEEN PREPARED IN DIGITAL FORMAT CLIENT/CLIENT'S REPRESENTATIVE OR CONSULTANTS MAY BE PROVIDED COPIES OF DRAWINGS AND SPECIFICATIONS FOR HIS/HER INFORMATION AND/OR SPECIFIC USE ON THIS PROJECT. DUE TO THE POTENTIAL THAT THE PROVIDED INFORMATION MAY BE MODIFIED UNINTENTIONALLY OR OTHERWISE, ALLEN & MAJOR ASSOCIATES, INC. MAY REMOVE ALL INDICATION OF THE DOCUMENT'S AUTHORSHIP ON THE DIGITAL MEDIA. PRINTED REPRESENTATIONS OR PORTABLE DOCUMENT FORMAT OF THE DRAWINGS AND SPECIFICATIONS ISSUED SHALL BE THE ONLY RECORD COPIES OF ALLEN & MAJOR ASSOCIATES, INC.'S WORK PRODUCT.

DRAWING TITLE:

LAYOUT PLAN

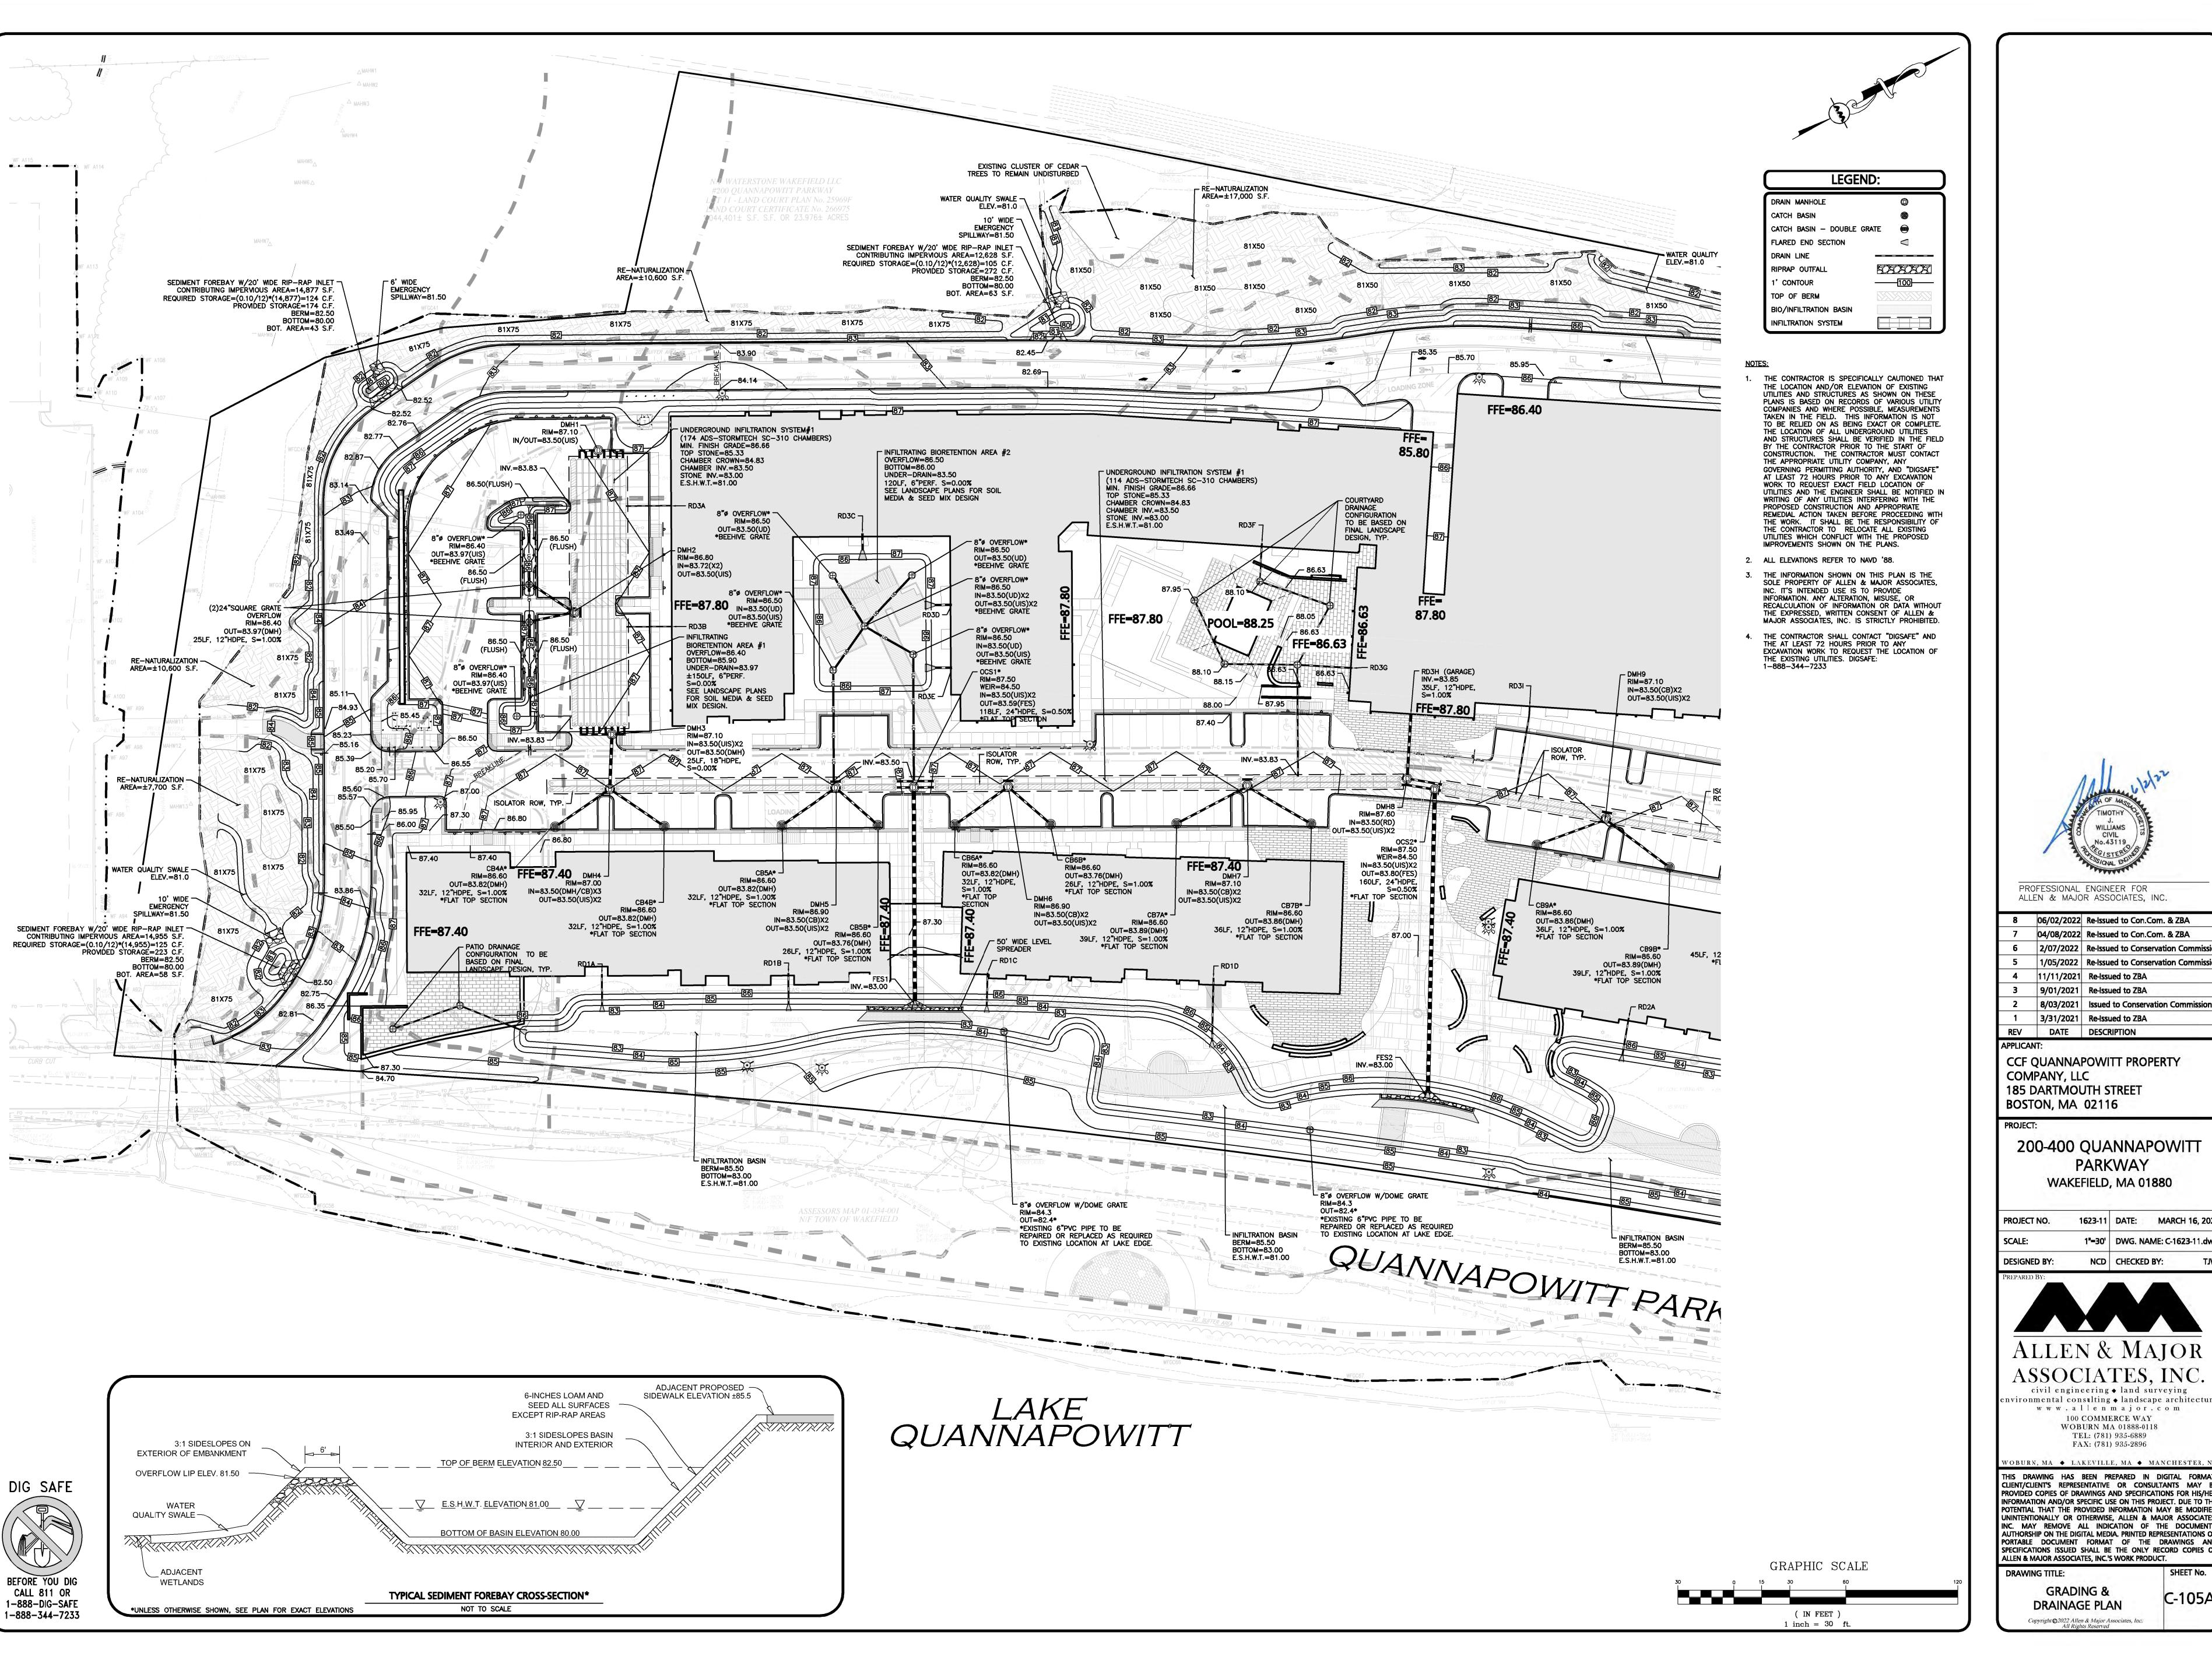



7	04/08/2022	Re-Issued to Con.Com. & ZBA
6	2/07/2022	Re-Issued to Conservation Commission
5	1/05/2022	Re-Issued to Conservation Commission
4	11/11/2021	Re-Issued to ZBA
3	9/01/2021	Re-Issued to ZBA
2	8/03/2021	Issued to Conservation Commission
1	3/31/2021	Re-Issued to ZBA
REV	DATE	DESCRIPTION

06/02/2022 Re-Issued to Con.Com. & ZBA

CCF QUANNAPOWITT PROPERTY COMPANY, LLC **185 DARTMOUTH STREET** BOSTON, MA 02116

200-400 QUANNAPOWITT **PARKWAY** WAKEFIELD, MA 01880

1"=30' DWG. NAME: C-1623-11.dw **DESIGNED BY:** NCD | CHECKED BY:



ASSOCIATES, INC. civil engineering ◆ land surveying vironmental consulting • landscape architecture


www.allenmajor.com 100 COMMERCE WAY WOBURN MA 01888-0118 TEL: (781) 935-6889 FAX: (781) 935-2896

THIS DRAWING HAS BEEN PREPARED IN DIGITAL FORMAT. CLIENT/CLIENT'S REPRESENTATIVE OR CONSULTANTS MAY BE PROVIDED COPIES OF DRAWINGS AND SPECIFICATIONS FOR HIS/HER INFORMATION AND/OR SPECIFIC USE ON THIS PROJECT. DUE TO THE POTENTIAL THAT THE PROVIDED INFORMATION MAY BE MODIFIED UNINTENTIONALLY OR OTHERWISE, ALLEN & MAJOR ASSOCIATES, INC. MAY REMOVE ALL INDICATION OF THE DOCUMENT'S AUTHORSHIP ON THE DIGITAL MEDIA. PRINTED REPRESENTATIONS OR PORTABLE DOCUMENT FORMAT OF THE DRAWINGS AND SPECIFICATIONS ISSUED SHALL BE THE ONLY RECORD COPIES OF ALLEN & MAJOR ASSOCIATES, INC.'S WORK PRODUCT.

DRAWING TITLE: **GRADING & DRAINAGE PLAN**

C-105A Copyright ©2022 Allen & Major Associates, Inc. All Rights Reserved

SHEET No.

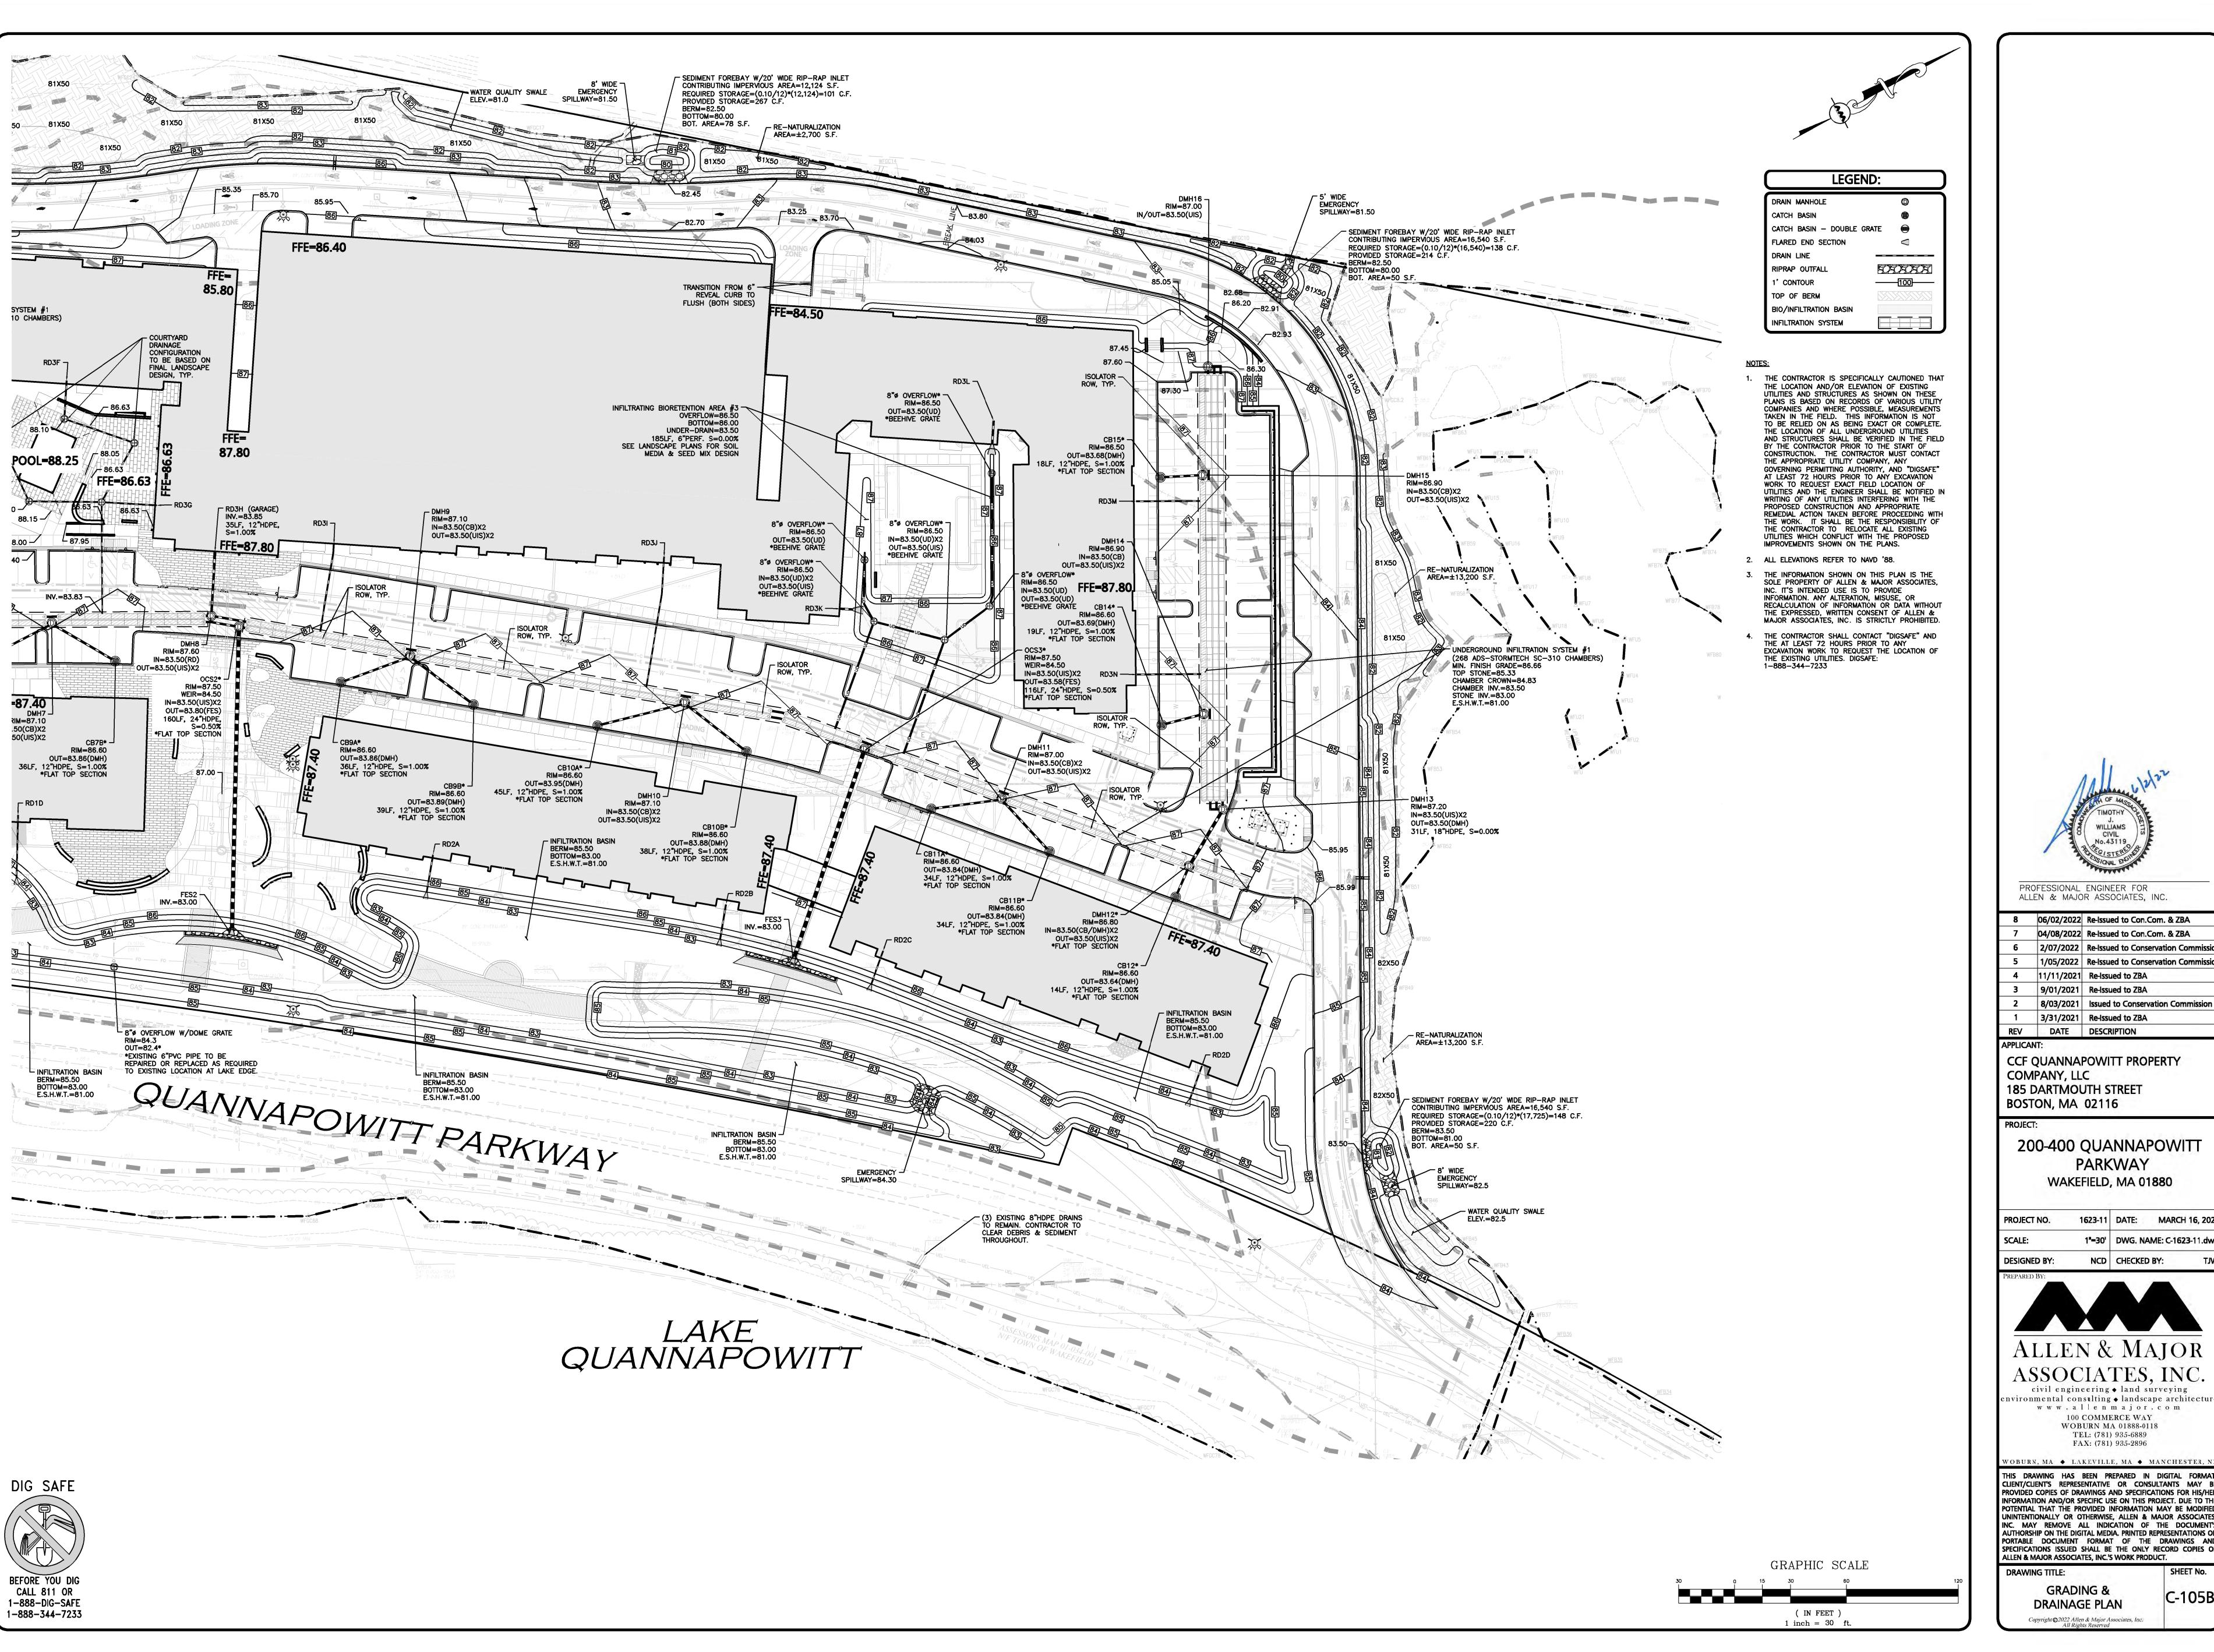



9/01/2021 Re-Issued to ZBA 8/03/2021 Issued to Conservation Commissio 3/31/2021 Re-Issued to ZBA DATE DESCRIPTION

CCF QUANNAPOWITT PROPERTY COMPANY, LLC **185 DARTMOUTH STREET** BOSTON, MA 02116

200-400 QUANNAPOWITT **PARKWAY** WAKEFIELD, MA 01880

1"=30' DWG. NAME: C-1623-11.dw NCD | CHECKED BY:




ASSOCIATES, INC. civil engineering ◆ land surveying

ivironmental consulting • landscape architecture www.allenmajor.com 100 COMMERCE WAY WOBURN MA 01888-0118 TEL: (781) 935-6889

FAX: (781) 935-2896

THIS DRAWING HAS BEEN PREPARED IN DIGITAL FORMAT. CLIENT/CLIENT'S REPRESENTATIVE OR CONSULTANTS MAY BE PROVIDED COPIES OF DRAWINGS AND SPECIFICATIONS FOR HIS/HER INFORMATION AND/OR SPECIFIC USE ON THIS PROJECT. DUE TO THE POTENTIAL THAT THE PROVIDED INFORMATION MAY BE MODIFIED UNINTENTIONALLY OR OTHERWISE, ALLEN & MAJOR ASSOCIATES, INC. MAY REMOVE ALL INDICATION OF THE DOCUMENT'S AUTHORSHIP ON THE DIGITAL MEDIA. PRINTED REPRESENTATIONS OR PORTABLE DOCUMENT FORMAT OF THE DRAWINGS AND SPECIFICATIONS ISSUED SHALL BE THE ONLY RECORD COPIES OF ALLEN & MAJOR ASSOCIATES, INC.'S WORK PRODUCT.

DRAWING TITLE: **GRADING &**

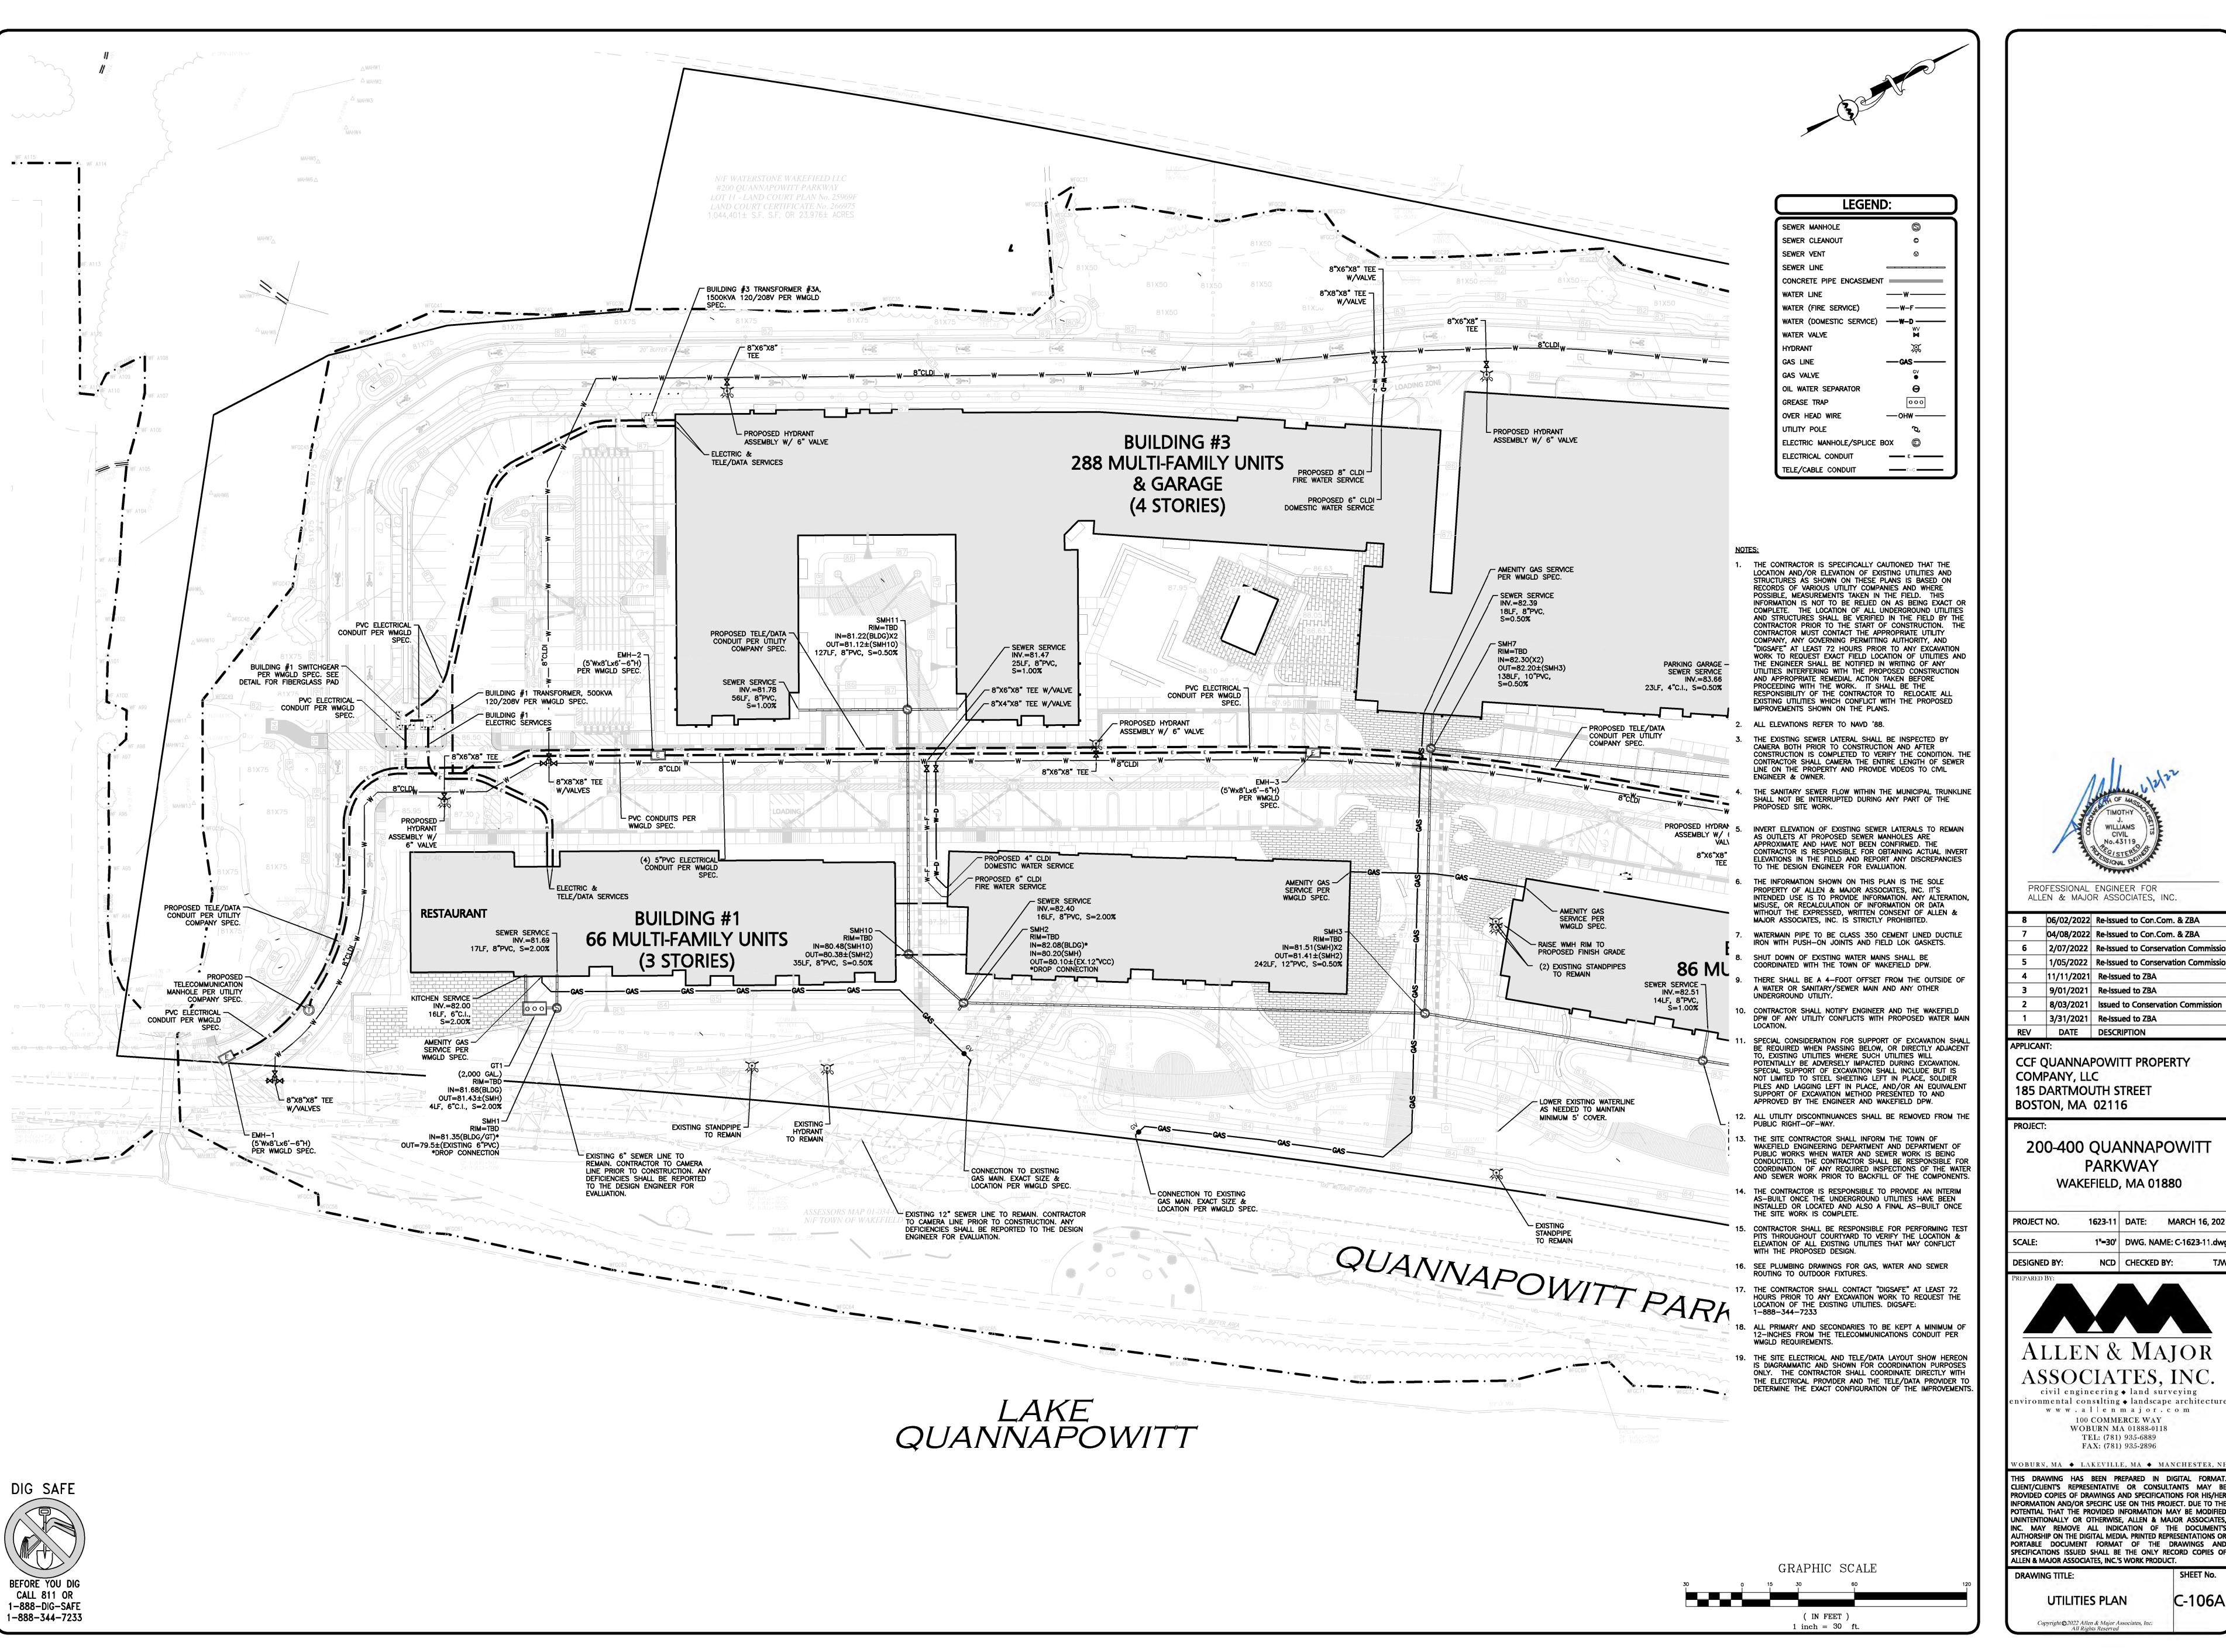



8 06/02/2022 Re-Issued to Con.Com. & ZBA 04/08/2022 Re-Issued to Con.Com. & ZBA 2/07/2022 Re-Issued to Conservation Commiss 1/05/2022 | Re-Issued to Conservation Commiss 4 | 11/11/2021 | Re-Issued to ZBA 9/01/2021 Re-Issued to ZBA 8/03/2021 Issued to Conservation Commission

CCF QUANNAPOWITT PROPERTY COMPANY, LLC **185 DARTMOUTH STREET**

3/31/2021 Re-Issued to ZBA

DATE DESCRIPTION

200-400 QUANNAPOWITT **PARKWAY** WAKEFIELD, MA 01880

1623-11 DATE: MARCH 16, 2021

SCALE: 1"=30' DWG. NAME: C-1623-11.dw **DESIGNED BY:** NCD | CHECKED BY:




civil engineering • land surveying rvironmental consulting ♦ landscape architecture www.allenmajor.com 100 COMMERCE WAY


WOBURN MA 01888-0118 TEL: (781) 935-6889

FAX: (781) 935-2896 WOBURN, MA ♦ LAKEVILLE, MA ♦ MANCHESTER, N THIS DRAWING HAS BEEN PREPARED IN DIGITAL FORMAT CLIENT/CLIENT'S REPRESENTATIVE OR CONSULTANTS MAY B PROVIDED COPIES OF DRAWINGS AND SPECIFICATIONS FOR HIS/HER INFORMATION AND/OR SPECIFIC USE ON THIS PROJECT. DUE TO THE POTENTIAL THAT THE PROVIDED INFORMATION MAY BE MODIFIED UNINTENTIONALLY OR OTHERWISE, ALLEN & MAJOR ASSOCIATES,

ALLEN & MAJOR ASSOCIATES, INC.'S WORK PRODUCT. DRAWING TITLE: SHEET No.

> C-106A **UTILITIES PLAN** Copyright ©2022 Allen & Major Associates, Inc. All Rights Reserved

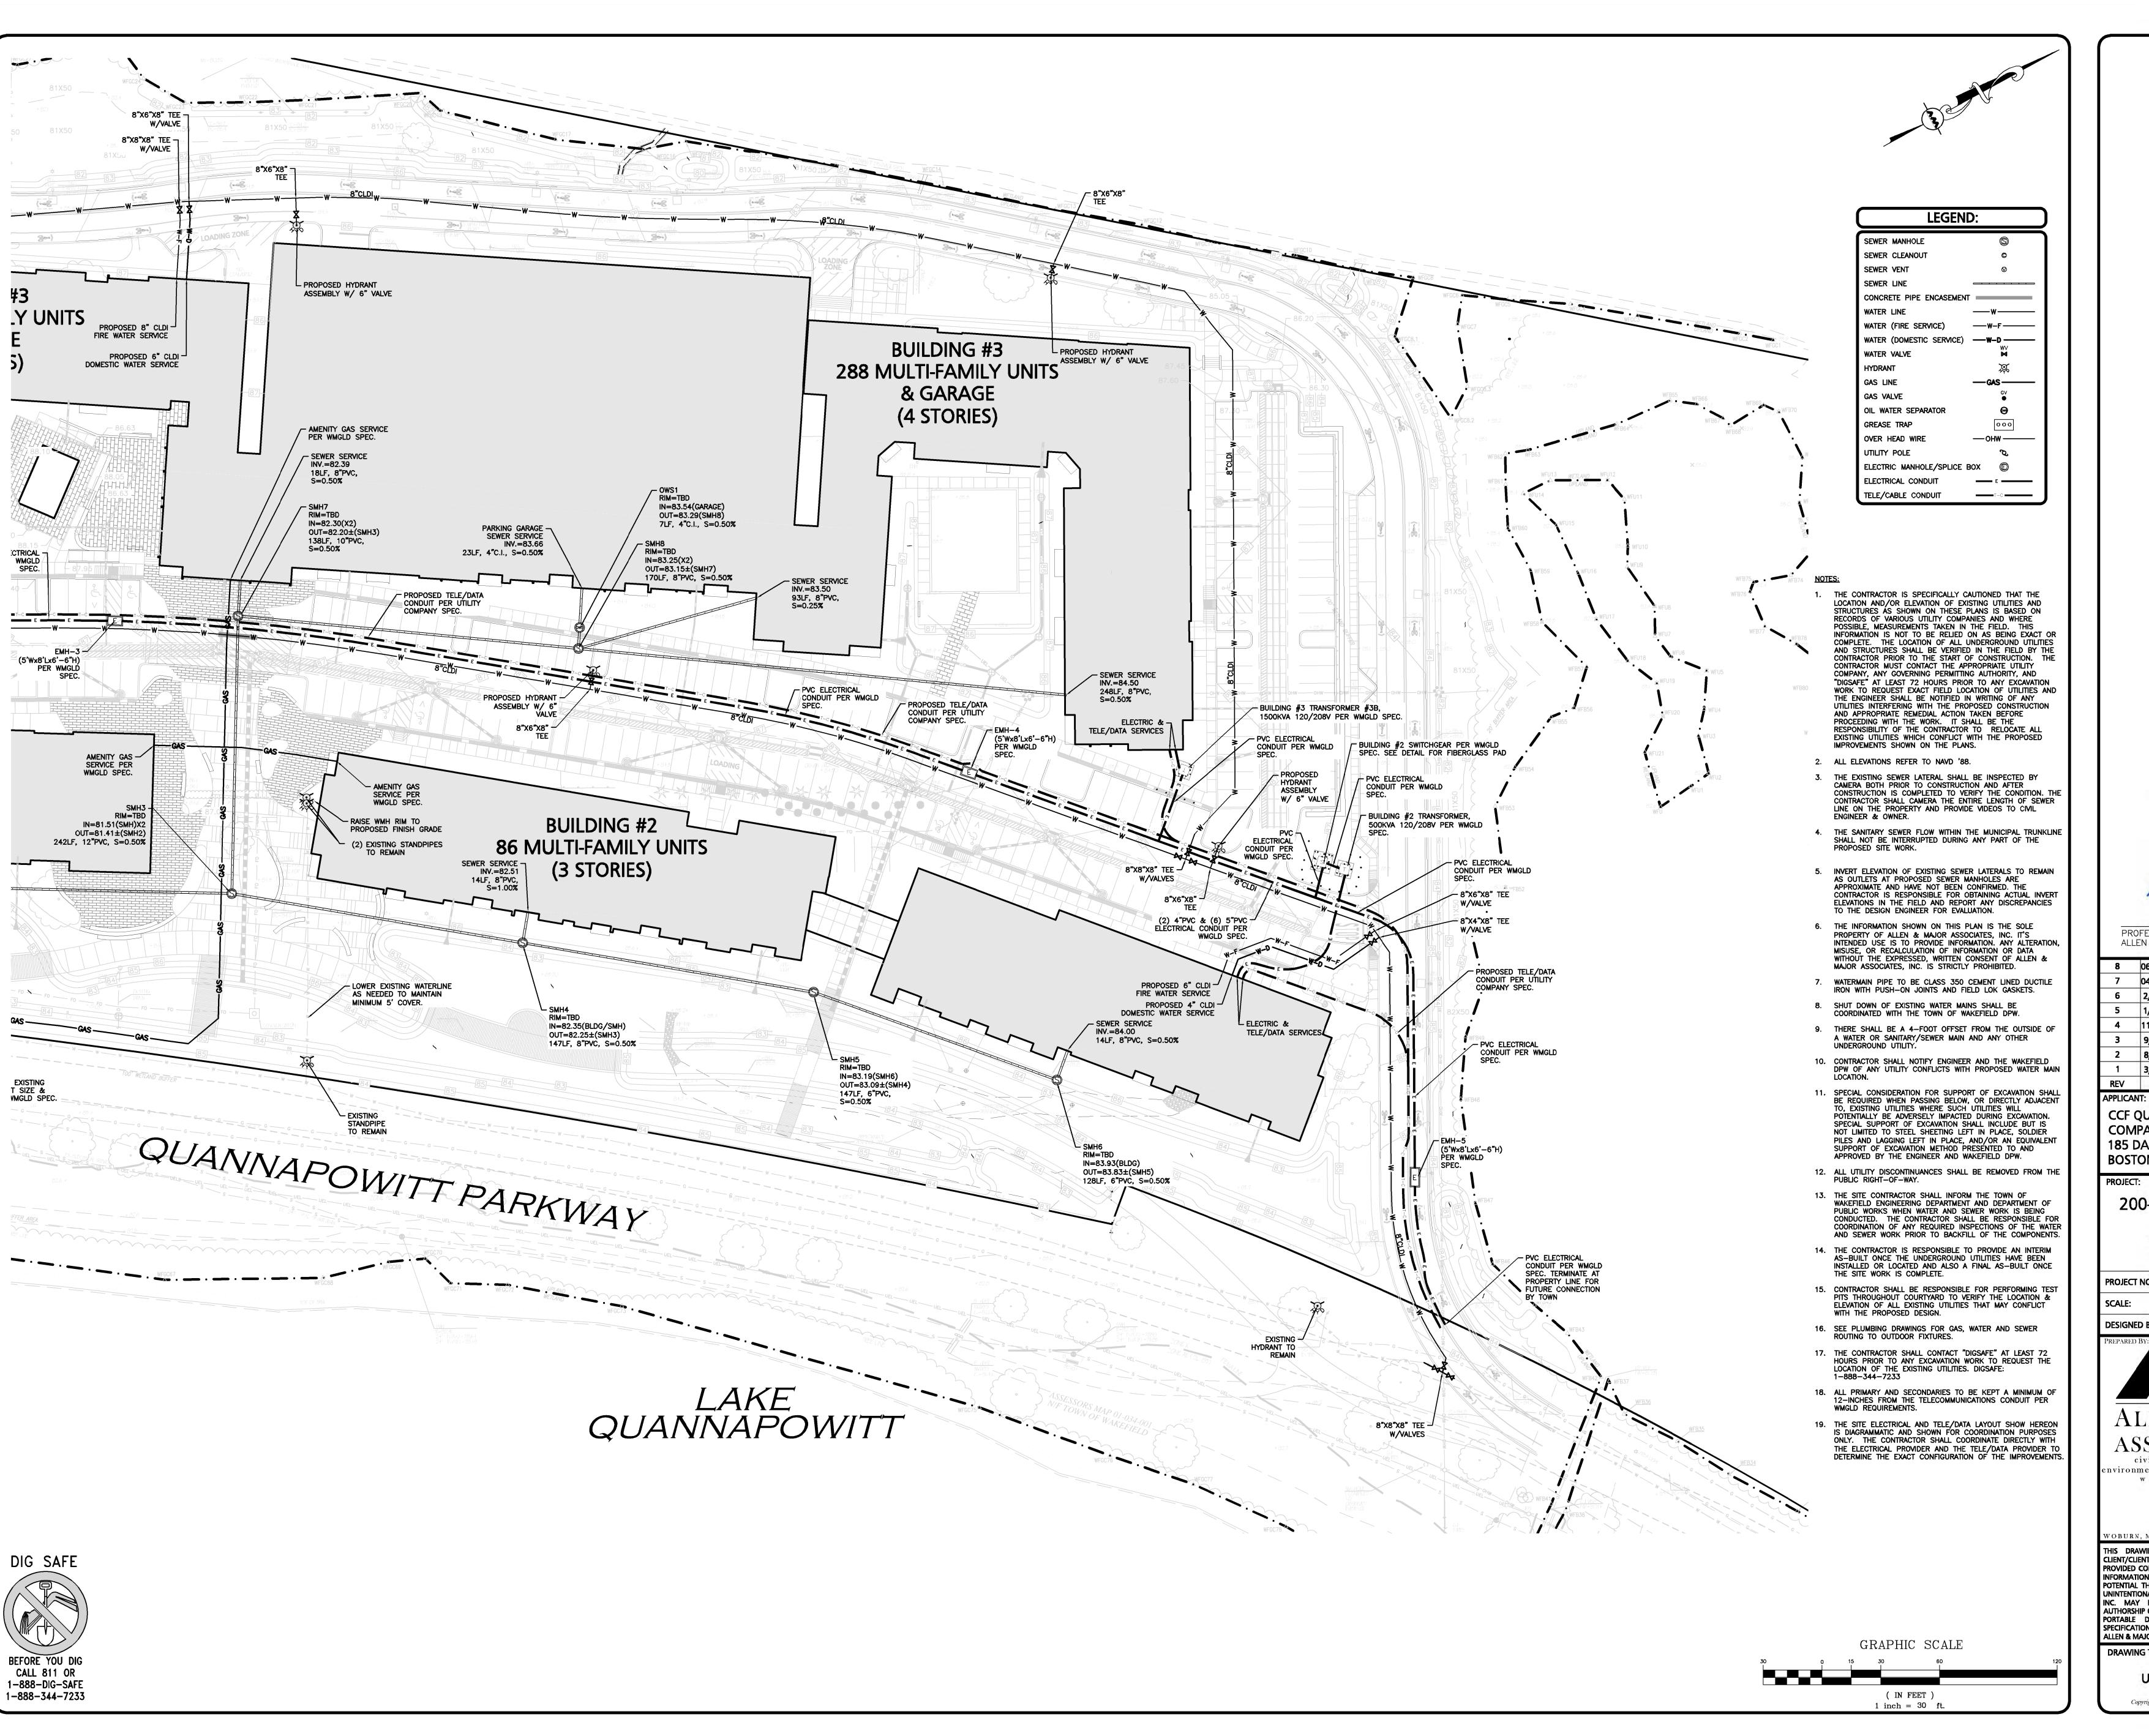

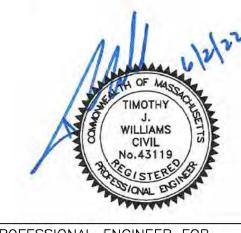

8 06/02/2022 Re-Issued to Con.Com. & ZBA 04/08/2022 Re-Issued to Con.Com. & ZBA 2/07/2022 | Re-Issued to Conservation Commiss 1/05/2022 | Re-Issued to Conservation Commiss 4 | 11/11/2021 | Re-Issued to ZBA 9/01/2021 Re-Issued to ZBA 8/03/2021 Issued to Conservation Commission 3/31/2021 Re-Issued to ZBA DATE DESCRIPTION

CCF QUANNAPOWITT PROPERTY COMPANY, LLC **185 DARTMOUTH STREET** BOSTON, MA 02116

200-400 QUANNAPOWITT **PARKWAY** WAKEFIELD, MA 01880

1623-11 DATE: MARCH 16, 202 1"=30' DWG. NAME: C-1623-11.dw **DESIGNED BY:** NCD | CHECKED BY:



ASSOCIATES, INC. civil engineering ◆ land surveying


nvironmental consulting • landscape architecture www.allenmajor.com 100 COMMERCE WAY WOBURN MA 01888-0118

TEL: (781) 935-6889 FAX: (781) 935-2896 WOBURN, MA . LAKEVILLE, MA . MANCHESTER, N

THIS DRAWING HAS BEEN PREPARED IN DIGITAL FORMAT. CLIENT/CLIENT'S REPRESENTATIVE OR CONSULTANTS MAY BE PROVIDED COPIES OF DRAWINGS AND SPECIFICATIONS FOR HIS/HER INFORMATION AND/OR SPECIFIC USE ON THIS PROJECT. DUE TO THE POTENTIAL THAT THE PROVIDED INFORMATION MAY BE MODIFIED UNINTENTIONALLY OR OTHERWISE, ALLEN & MAJOR ASSOCIATES, INC. MAY REMOVE ALL INDICATION OF THE DOCUMENT'S AUTHORSHIP ON THE DIGITAL MEDIA. PRINTED REPRESENTATIONS OR PORTABLE DOCUMENT FORMAT OF THE DRAWINGS AND SPECIFICATIONS ISSUED SHALL BE THE ONLY RECORD COPIES OF ALLEN & MAJOR ASSOCIATES, INC.'S WORK PRODUCT.

DRAWING TITLE:

UTILITIES PLAN

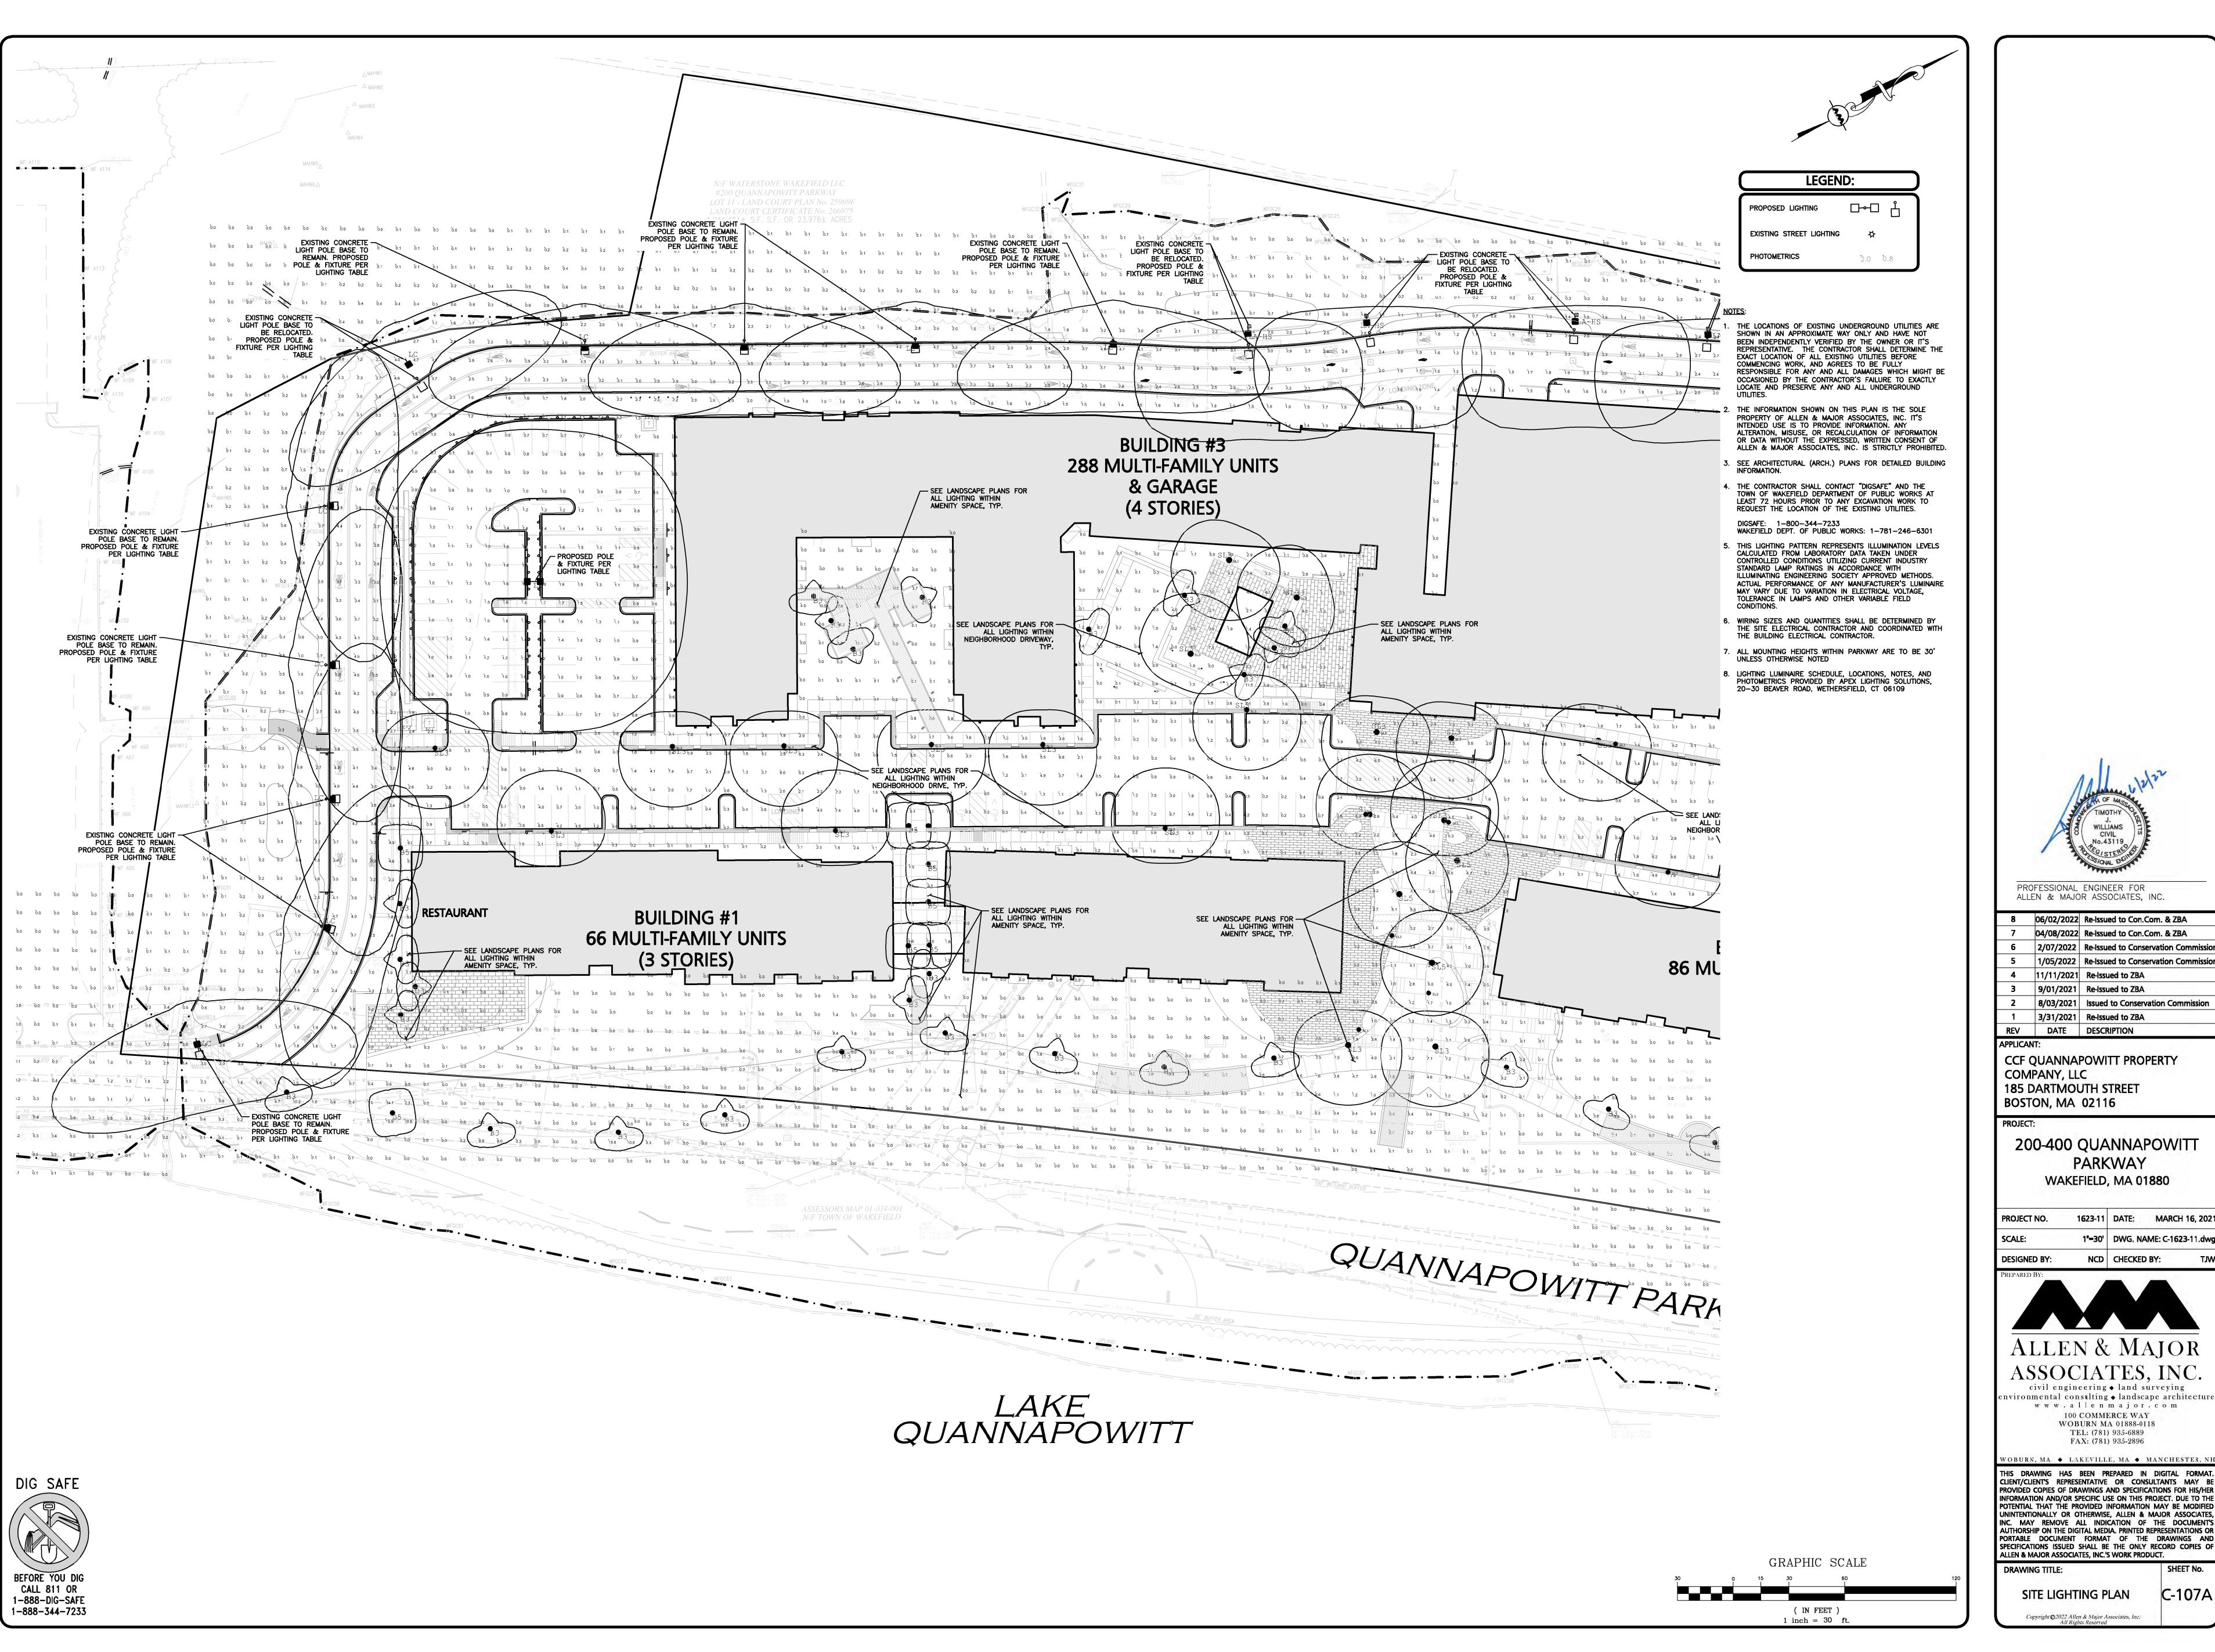



_	00/02/2022	THE IDEACH TO COLLICOTHIN C. EDIT
7	04/08/2022	Re-Issued to Con.Com. & ZBA
6	2/07/2022	Re-Issued to Conservation Commission
5	1/05/2022	Re-Issued to Conservation Commission
4	11/11/2021	Re-Issued to ZBA
3	9/01/2021	Re-Issued to ZBA
2	8/03/2021	Issued to Conservation Commission
1	3/31/2021	Re-Issued to ZBA
EV	DATE	DESCRIPTION

CCF QUANNAPOWITT PROPERTY COMPANY, LLC **185 DARTMOUTH STREET** BOSTON, MA 02116

200-400 QUANNAPOWITT **PARKWAY** WAKEFIELD, MA 01880

1"=30' DWG. NAME: C-1623-11.dw NCD CHECKED BY:



ALLEN & MAJOR ASSOCIATES, INC.


civil engineering ◆ land surveying nvironmental consulting ♦ landscape architecture www.allenmajor.com 100 COMMERCE WAY WOBURN MA 01888-0118 TEL: (781) 935-6889

FAX: (781) 935-2896

WOBURN, MA ♦ LAKEVILLE, MA ♦ MANCHESTER, N. THIS DRAWING HAS BEEN PREPARED IN DIGITAL FORMAT CLIENT/CLIENT'S REPRESENTATIVE OR CONSULTANTS MAY BE PROVIDED COPIES OF DRAWINGS AND SPECIFICATIONS FOR HIS/HER INFORMATION AND/OR SPECIFIC USE ON THIS PROJECT. DUE TO THE POTENTIAL THAT THE PROVIDED INFORMATION MAY BE MODIFIED UNINTENTIONALLY OR OTHERWISE, ALLEN & MAJOR ASSOCIATES, INC. MAY REMOVE ALL INDICATION OF THE DOCUMENT'S

ALLEN & MAJOR ASSOCIATES, INC.'S WORK PRODUCT. DRAWING TITLE:

C-107A SITE LIGHTING PLAN

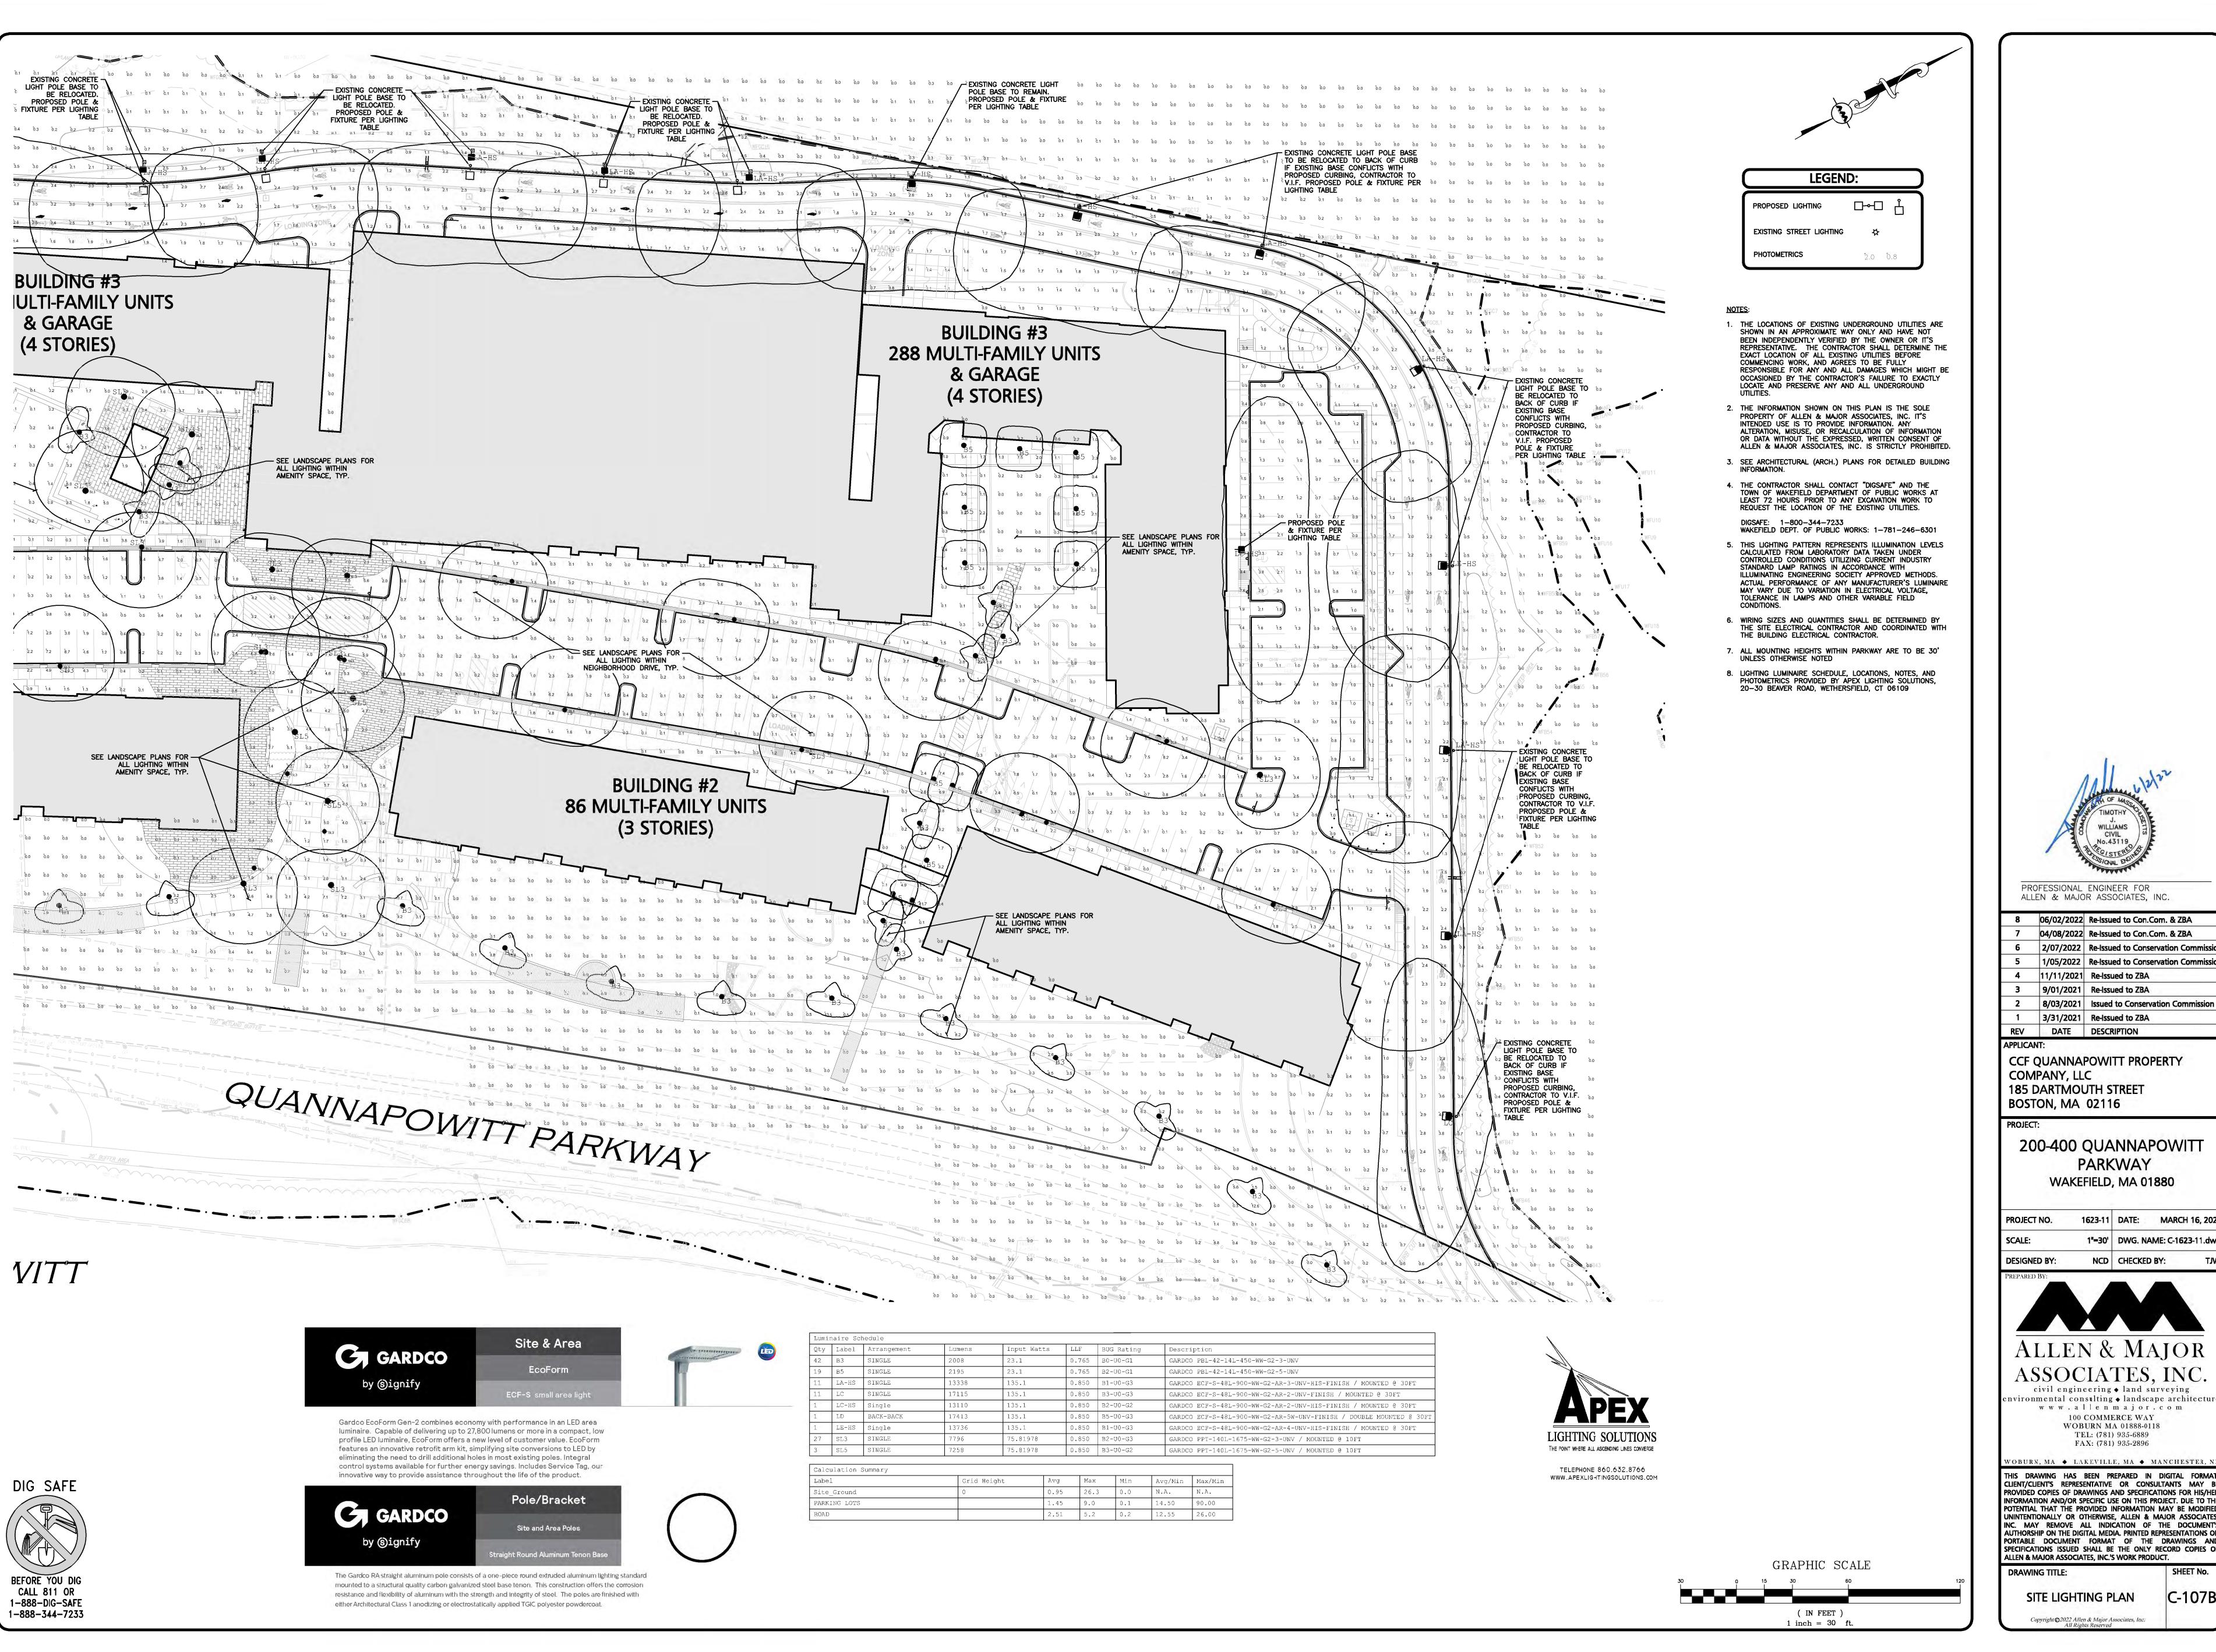



7	04/08/2022	Re-Issued to Con.Com. & ZBA
6	2/07/2022	Re-Issued to Conservation Commiss
5	1/05/2022	Re-Issued to Conservation Commiss
4	11/11/2021	Re-Issued to ZBA
3	9/01/2021	Re-Issued to ZBA
2	8/03/2021	Issued to Conservation Commission
1	3/31/2021	Re-Issued to ZBA
DE\/	DATE	DESCRIPTION

CCF QUANNAPOWITT PROPERTY COMPANY, LLC **185 DARTMOUTH STREET** BOSTON, MA 02116

200-400 QUANNAPOWITT **PARKWAY** WAKEFIELD, MA 01880

NCD | CHECKED BY:




ASSOCIATES, INC. civil engineering ◆ land surveying nvironmental consulting • landscape architecture


www.allenmajor.com 100 COMMERCE WAY WOBURN MA 01888-0118 TEL: (781) 935-6889 FAX: (781) 935-2896

THIS DRAWING HAS BEEN PREPARED IN DIGITAL FORMAT. CLIENT/CLIENT'S REPRESENTATIVE OR CONSULTANTS MAY BE PROVIDED COPIES OF DRAWINGS AND SPECIFICATIONS FOR HIS/HER INFORMATION AND/OR SPECIFIC USE ON THIS PROJECT. DUE TO THE POTENTIAL THAT THE PROVIDED INFORMATION MAY BE MODIFIED UNINTENTIONALLY OR OTHERWISE, ALLEN & MAJOR ASSOCIATES, INC. MAY REMOVE ALL INDICATION OF THE DOCUMENT'S AUTHORSHIP ON THE DIGITAL MEDIA. PRINTED REPRESENTATIONS OR PORTABLE DOCUMENT FORMAT OF THE DRAWINGS AND SPECIFICATIONS ISSUED SHALL BE THE ONLY RECORD COPIES OF ALLEN & MAJOR ASSOCIATES, INC.'S WORK PRODUCT.

DRAWING TITLE: SHEET No.

SITE LIGHTING PLAN

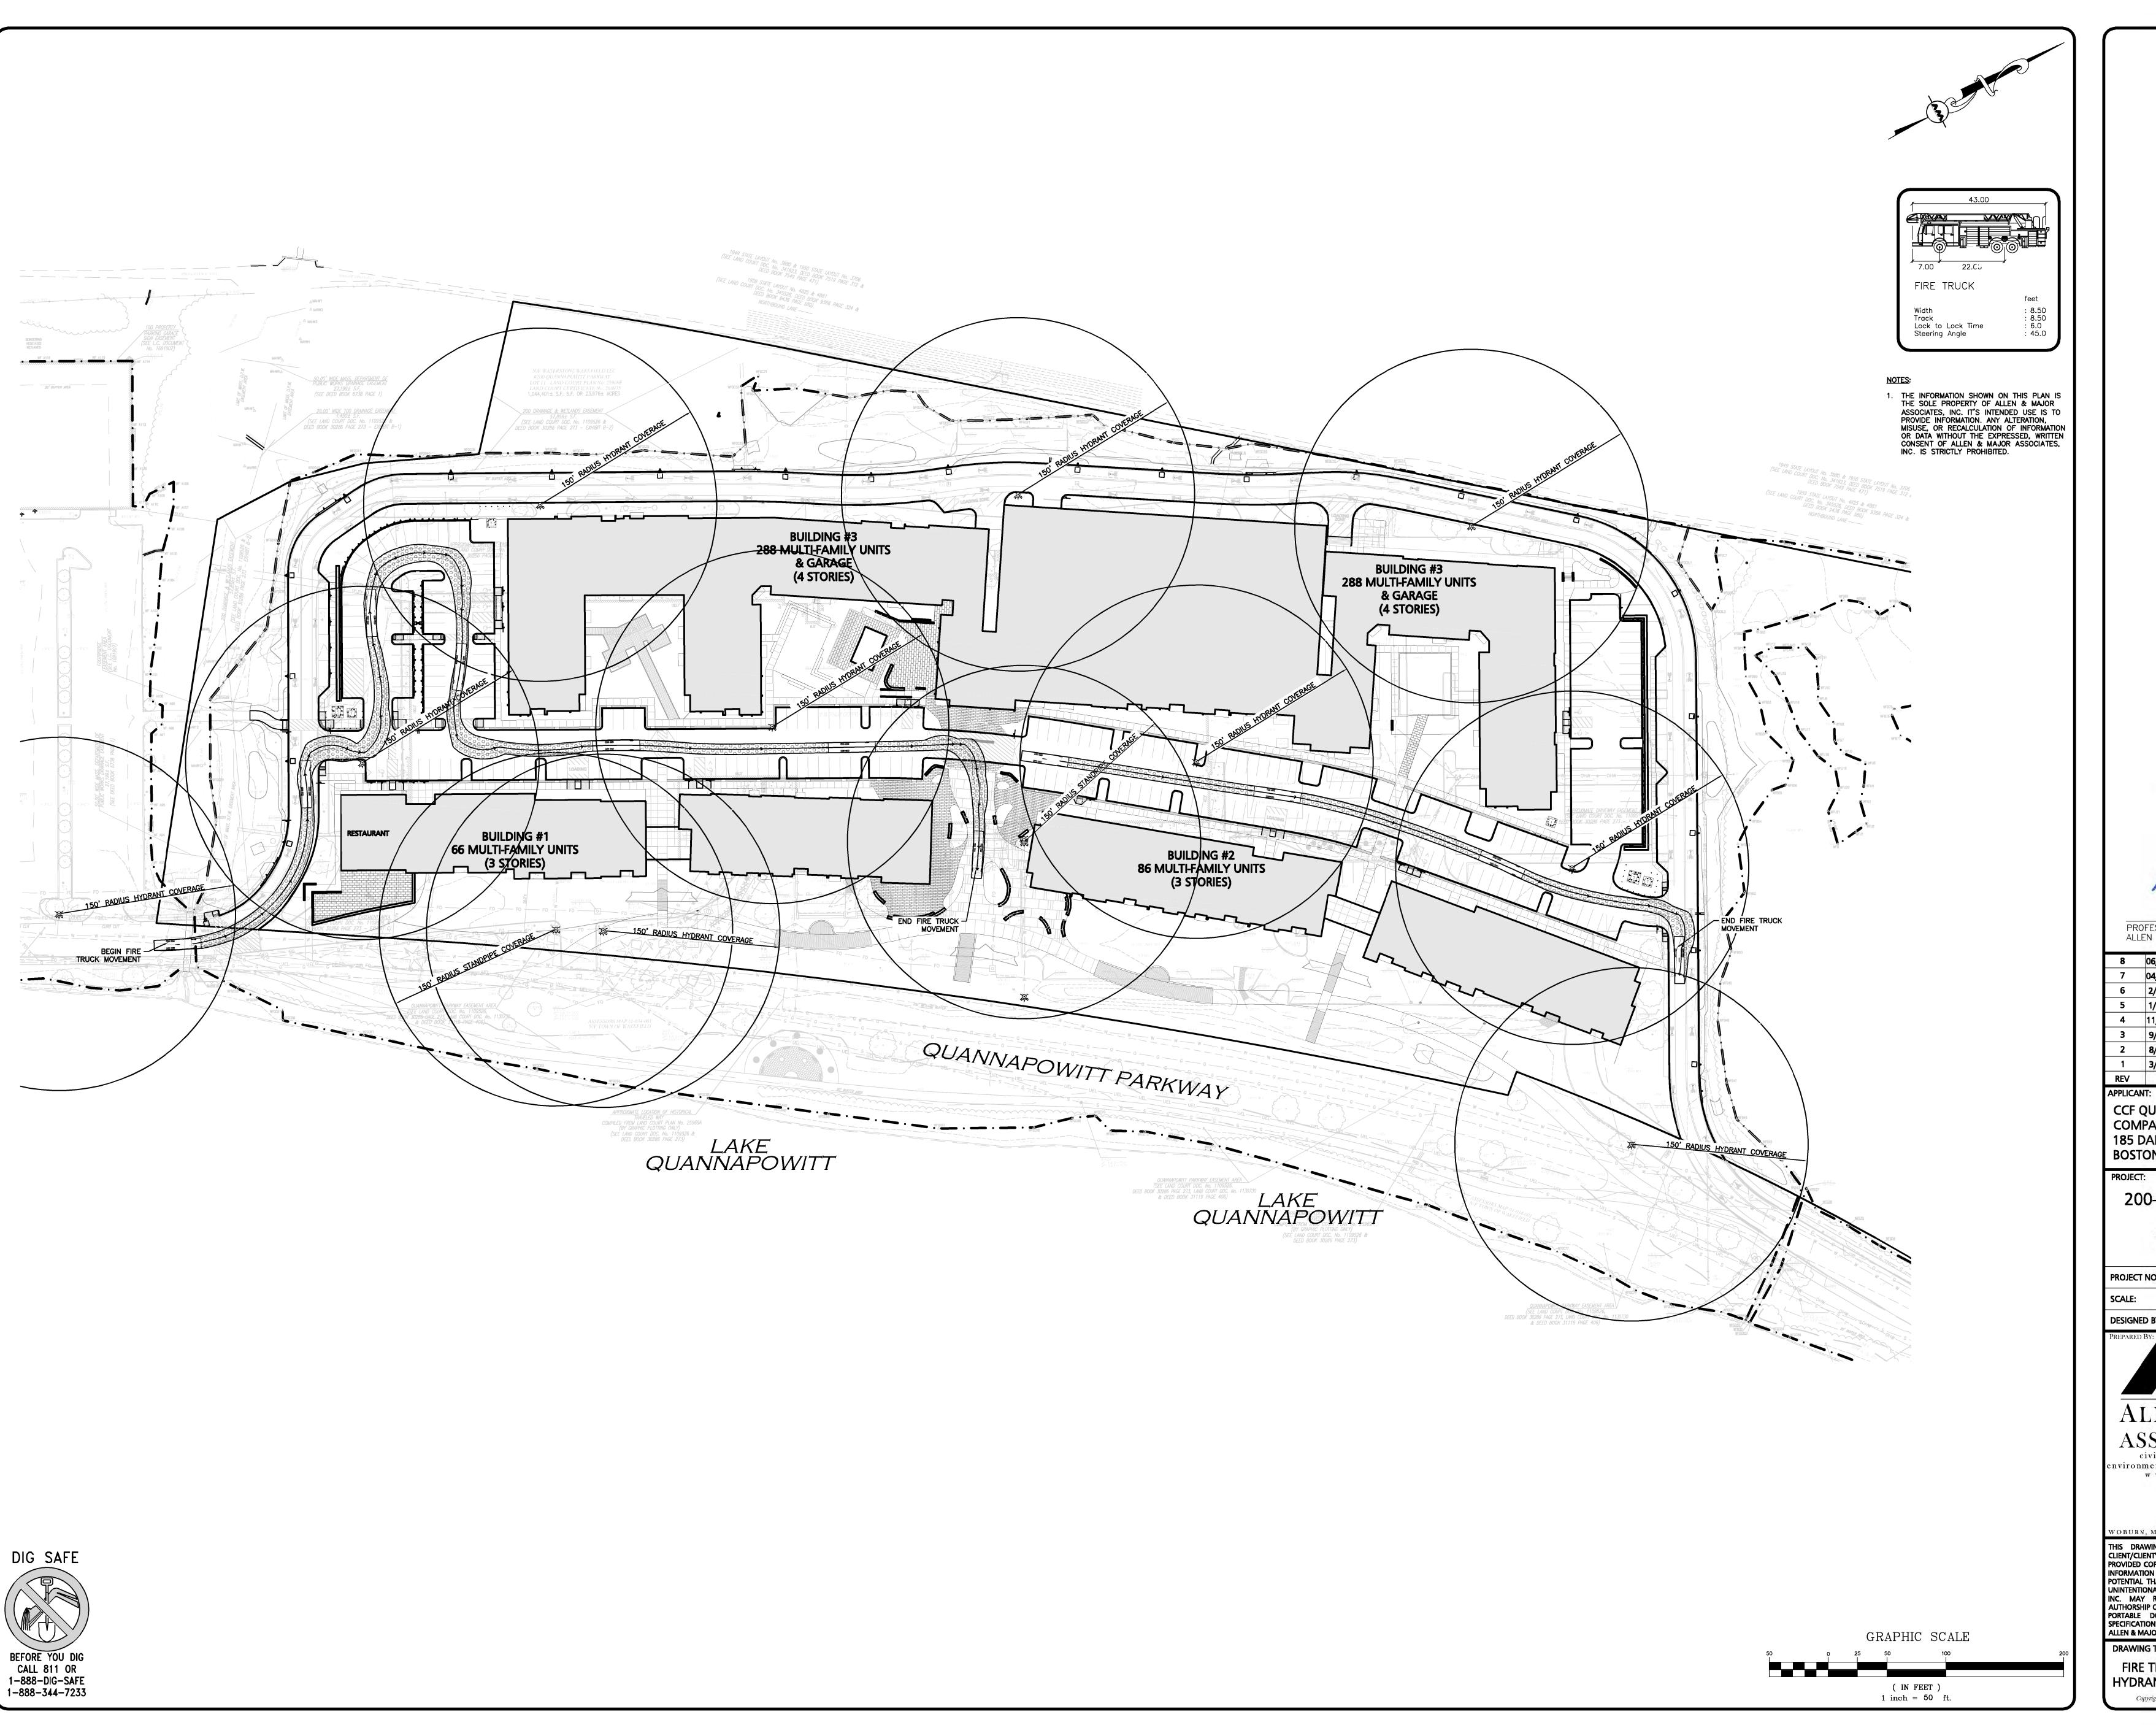

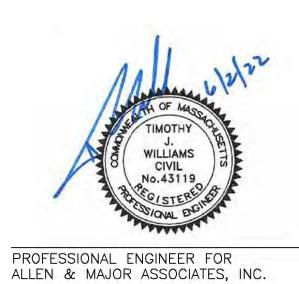

8 06/02/2022 Re-Issued to Con.Com. & ZBA 04/08/2022 Re-Issued to Con.Com. & ZBA

6 2/07/2022 Re-Issued to Conservation Commissi 5 1/05/2022 Re-Issued to Conservation Commissi 4 11/11/2021 Re-Issued to ZBA 3 9/01/2021 Re-Issued to ZBA 8/03/2021 Issued to Conservation Commission 3/31/2021 Re-Issued to ZBA REV DATE DESCRIPTION

CCF QUANNAPOWITT PROPERTY COMPANY, LLC 185 DARTMOUTH STREET BOSTON, MA 02116

200-400 QUANNAPOWITT **PARKWAY** WAKEFIELD, MA 01880

1623-11 DATE: MARCH 16, 2021

1"=50' DWG. NAME: C-1623-11.dwg NCD CHECKED BY: DESIGNED BY:




ASSOCIATES, INC. civil engineering ◆ land surveying


nvironmental consulting • landscape architecture www.allenmajor.com 100 COMMERCE WAY WOBURN MA 01888-0118 TEL: (781) 935-6889 FAX: (781) 935-2896

WOBURN, MA ♦ LAKEVILLE, MA ♦ MANCHESTER, NH THIS DRAWING HAS BEEN PREPARED IN DIGITAL FORMAT.

CLIENT/CLIENT'S REPRESENTATIVE OR CONSULTANTS MAY BE PROVIDED COPIES OF DRAWINGS AND SPECIFICATIONS FOR HIS/HER INFORMATION AND/OR SPECIFIC USE ON THIS PROJECT. DUE TO THE POTENTIAL THAT THE PROVIDED INFORMATION MAY BE MODIFIED UNINTENTIONALLY OR OTHERWISE, ALLEN & MAJOR ASSOCIATES, INC. MAY REMOVE ALL INDICATION OF THE DOCUMENT'S AUTHORSHIP ON THE DIGITAL MEDIA. PRINTED REPRESENTATIONS OR PORTABLE DOCUMENT FORMAT OF THE DRAWINGS AND SPECIFICATIONS ISSUED SHALL BE THE ONLY RECORD COPIES OF ALLEN & MAJOR ASSOCIATES, INC.'S WORK PRODUCT.

DRAWING TITLE: FIRE TRUCK TURNING & HYDRANT LOCATION PLAN

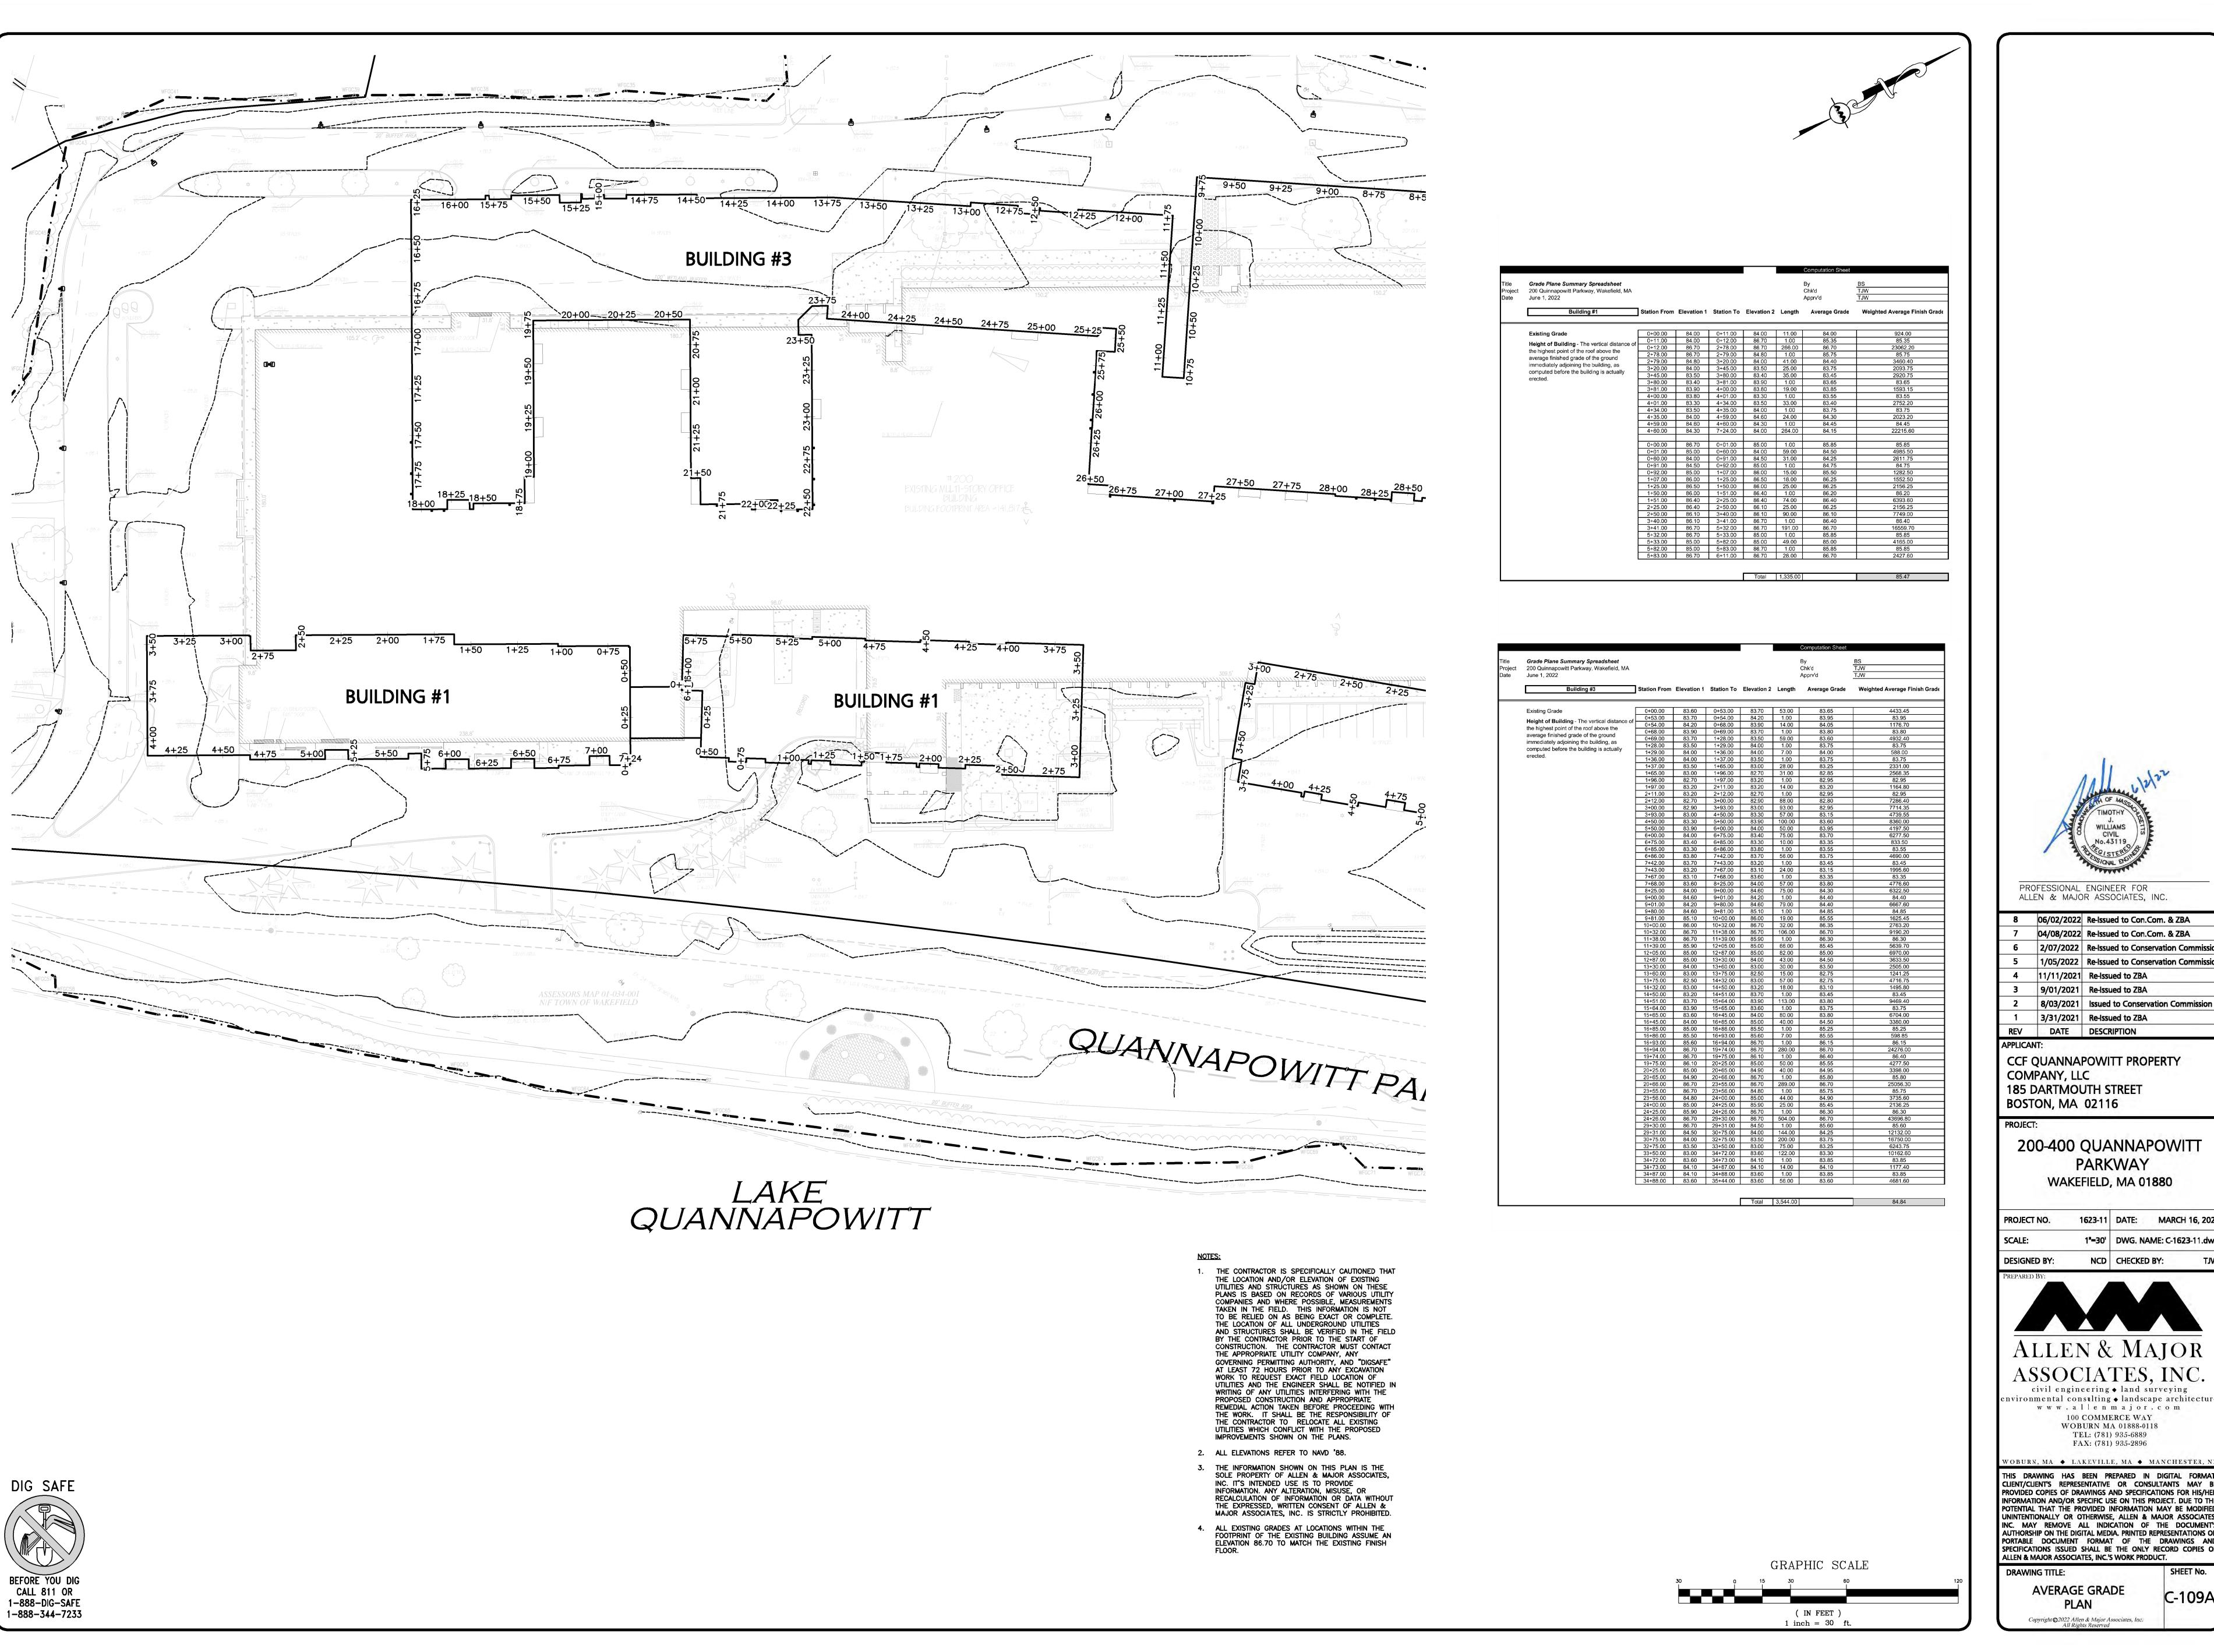

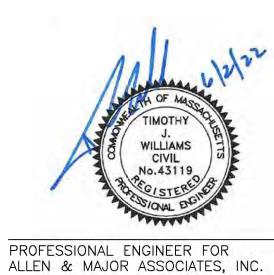

8 06/02/2022 Re-Issued to Con.Com. & ZBA 04/08/2022 Re-Issued to Con.Com. & ZBA 2/07/2022 | Re-Issued to Conservation Commission 1/05/2022 | Re-Issued to Conservation Commission 4 11/11/2021 Re-Issued to ZBA 9/01/2021 Re-Issued to ZBA 8/03/2021 Issued to Conservation Commission

APPLICANT: **CCF QUANNAPOWITT PROPERTY** COMPANY, LLC **185 DARTMOUTH STREET**

3/31/2021 Re-Issued to ZBA

200-400 QUANNAPOWITT **PARKWAY** WAKEFIELD, MA 01880

1623-11 DATE: MARCH 16, 2021

1"=30' DWG. NAME: C-1623-11.dwg **DESIGNED BY:** NCD CHECKED BY:





ASSOCIATES, INC. civil engineering ◆ land surveying nvironmental consulting • landscape architecture

www.allenmajor.com 100 COMMERCE WAY WOBURN MA 01888-0118 TEL: (781) 935-6889 FAX: (781) 935-2896

THIS DRAWING HAS BEEN PREPARED IN DIGITAL FORMAT. CLIENT/CLIENT'S REPRESENTATIVE OR CONSULTANTS MAY BE PROVIDED COPIES OF DRAWINGS AND SPECIFICATIONS FOR HIS/HER INFORMATION AND/OR SPECIFIC USE ON THIS PROJECT. DUE TO THE POTENTIAL THAT THE PROVIDED INFORMATION MAY BE MODIFIED UNINTENTIONALLY OR OTHERWISE, ALLEN & MAJOR ASSOCIATES, INC. MAY REMOVE ALL INDICATION OF THE DOCUMENT'S AUTHORSHIP ON THE DIGITAL MEDIA. PRINTED REPRESENTATIONS OR PORTABLE DOCUMENT FORMAT OF THE DRAWINGS AND SPECIFICATIONS ISSUED SHALL BE THE ONLY RECORD COPIES OF ALLEN & MAJOR ASSOCIATES, INC.'S WORK PRODUCT.

DRAWING TITLE: AVERAGE GRADE

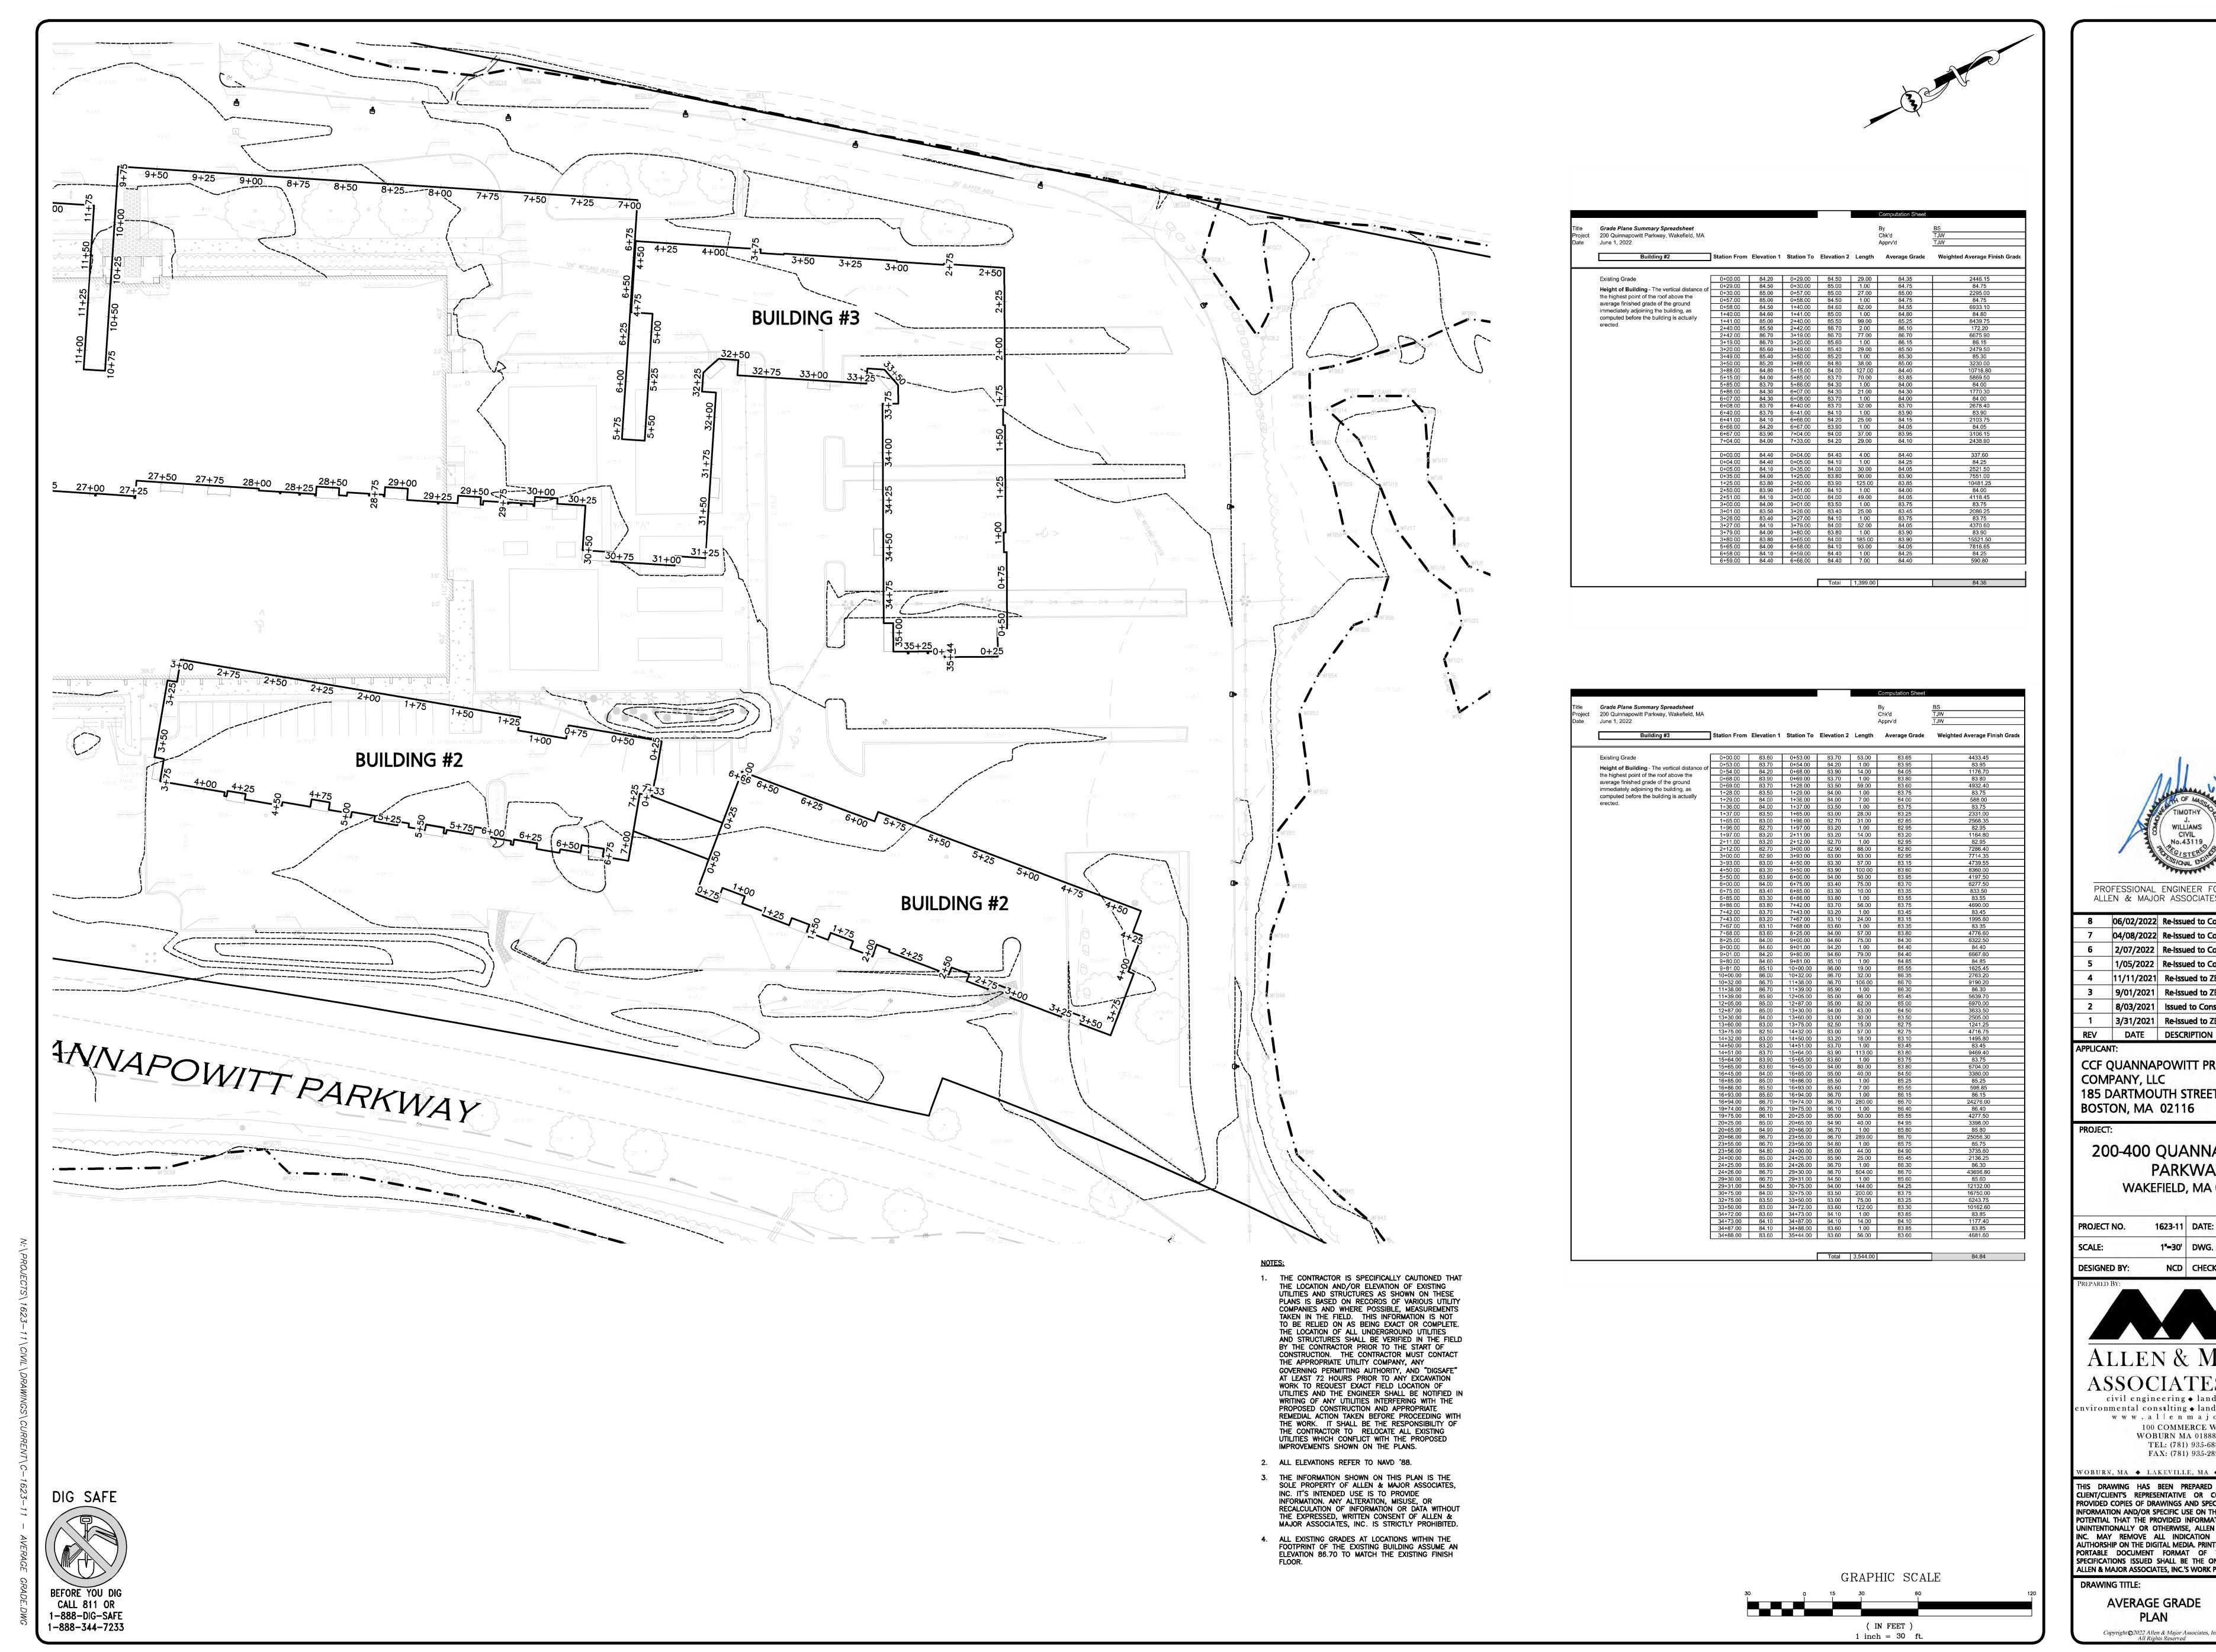

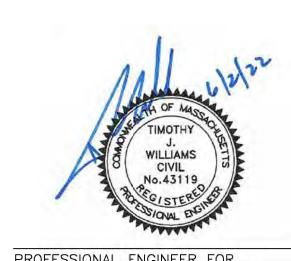

8 06/02/2022 Re-Issued to Con.Com. & ZBA 04/08/2022 Re-Issued to Con.Com. & ZBA 2/07/2022 | Re-Issued to Conservation Commission 1/05/2022 | Re-Issued to Conservation Commission 4 11/11/2021 Re-Issued to ZBA 9/01/2021 Re-Issued to ZBA 8/03/2021 Issued to Conservation Commission 3/31/2021 Re-Issued to ZBA

CCF QUANNAPOWITT PROPERTY COMPANY, LLC 185 DARTMOUTH STREET BOSTON, MA 02116

200-400 QUANNAPOWITT **PARKWAY** WAKEFIELD, MA 01880

1"=30' DWG. NAME: C-1623-11.dwg **DESIGNED BY:** NCD CHECKED BY:




ASSOCIATES, INC. civil engineering ◆ land surveying nvironmental consulting • landscape architecture


www.allenmajor.com 100 COMMERCE WAY WOBURN MA 01888-0118 TEL: (781) 935-6889


FAX: (781) 935-2896 WOBURN, MA ♦ LAKEVILLE, MA ♦ MANCHESTER, N THIS DRAWING HAS BEEN PREPARED IN DIGITAL FORMAT.


CLIENT/CLIENT'S REPRESENTATIVE OR CONSULTANTS MAY BE PROVIDED COPIES OF DRAWINGS AND SPECIFICATIONS FOR HIS/HER INFORMATION AND/OR SPECIFIC USE ON THIS PROJECT. DUE TO THE POTENTIAL THAT THE PROVIDED INFORMATION MAY BE MODIFIED UNINTENTIONALLY OR OTHERWISE, ALLEN & MAJOR ASSOCIATES, INC. MAY REMOVE ALL INDICATION OF THE DOCUMENT'S AUTHORSHIP ON THE DIGITAL MEDIA. PRINTED REPRESENTATIONS OR PORTABLE DOCUMENT FORMAT OF THE DRAWINGS AND SPECIFICATIONS ISSUED SHALL BE THE ONLY RECORD COPIES OF ALLEN & MAJOR ASSOCIATES, INC.'S WORK PRODUCT.


DRAWING TITLE: AVERAGE GRADE

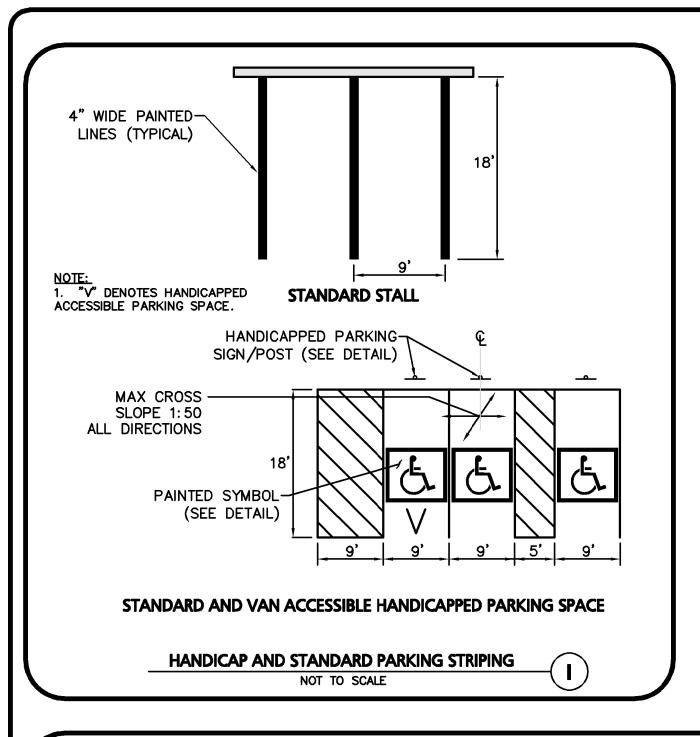


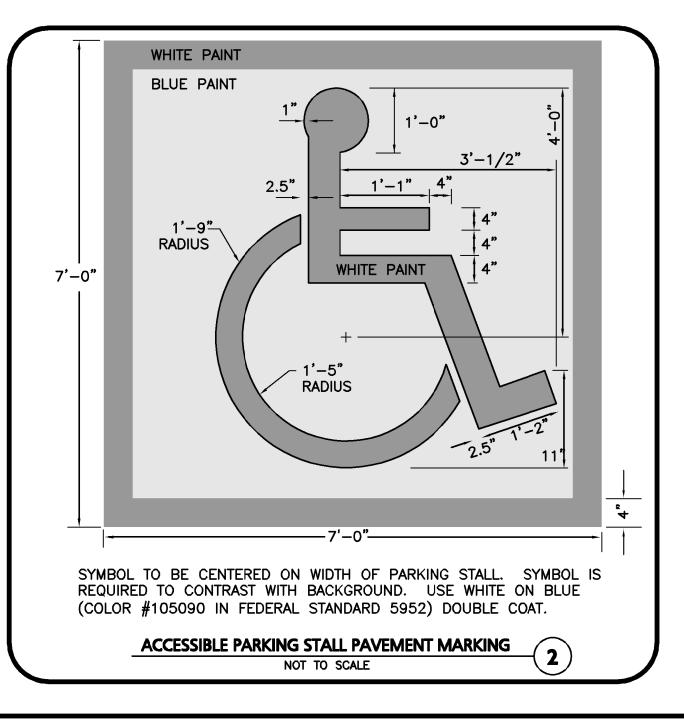


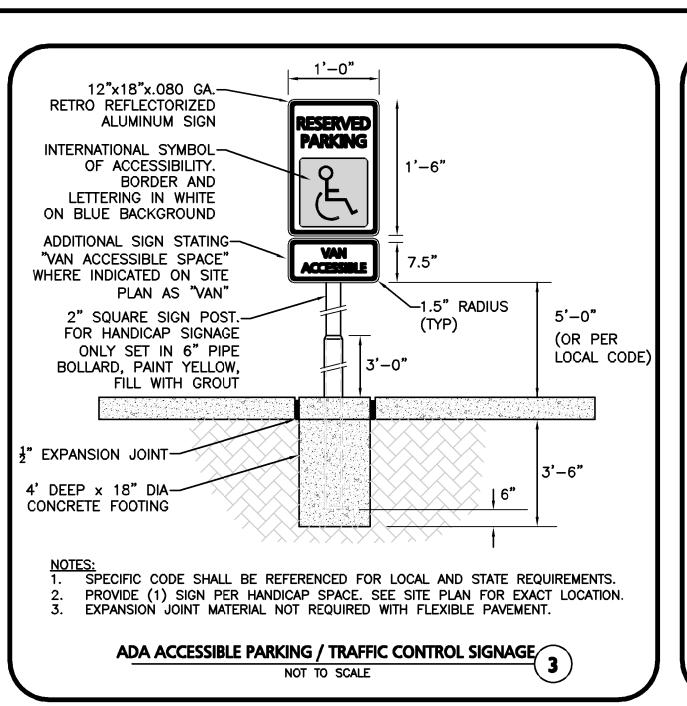


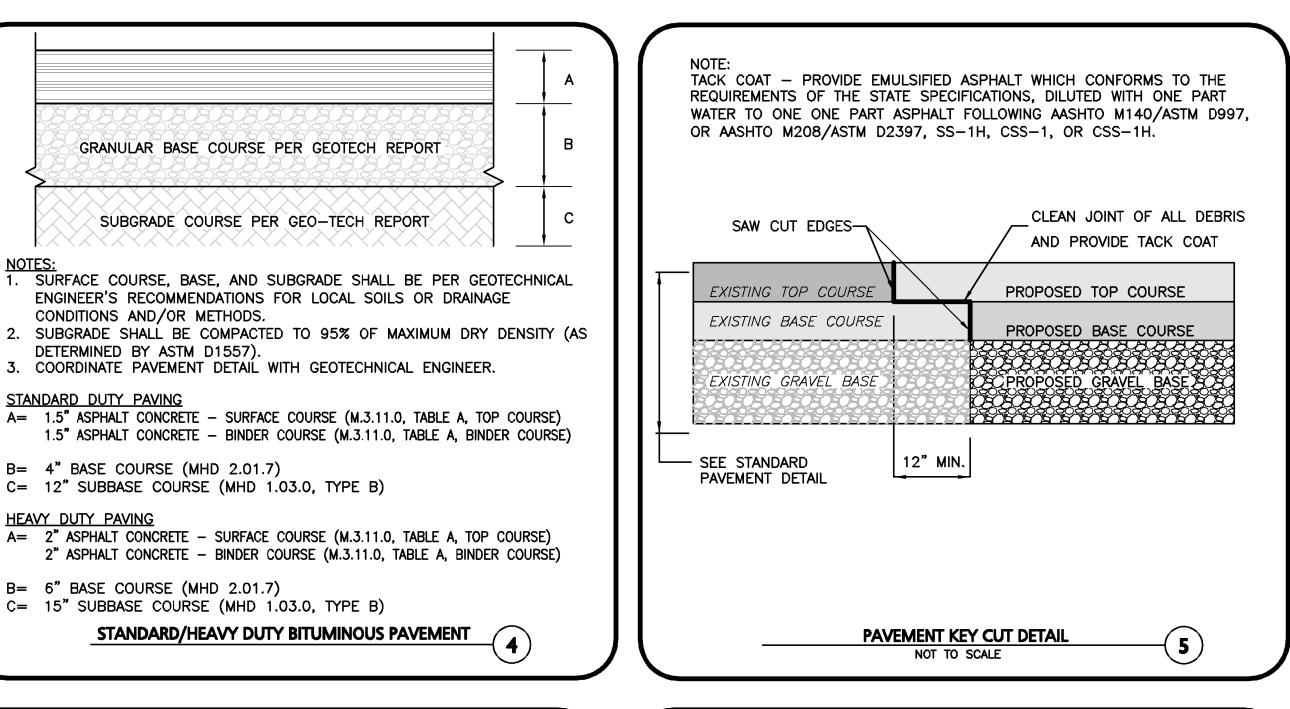


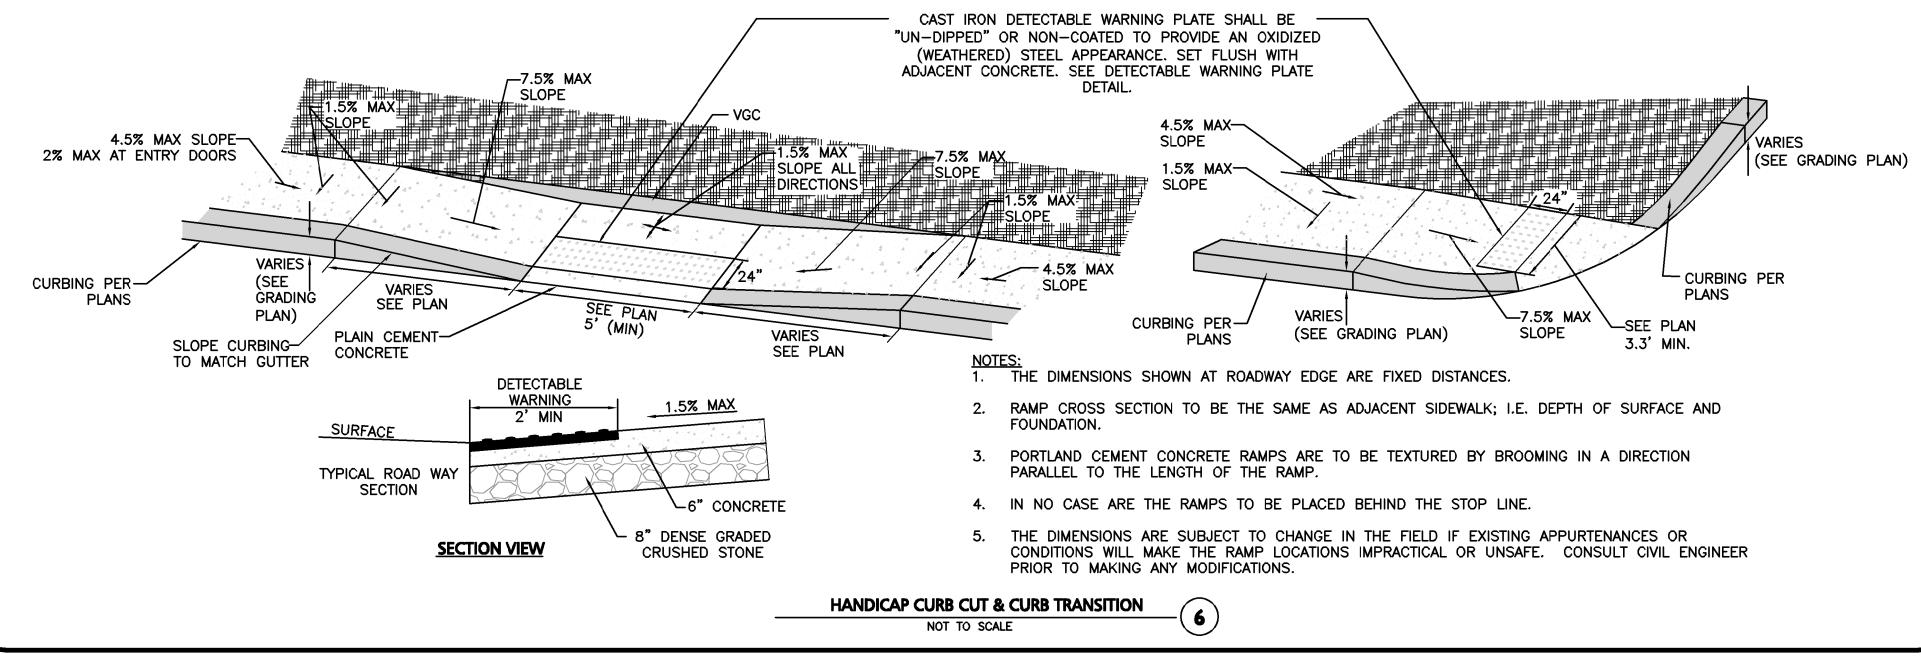


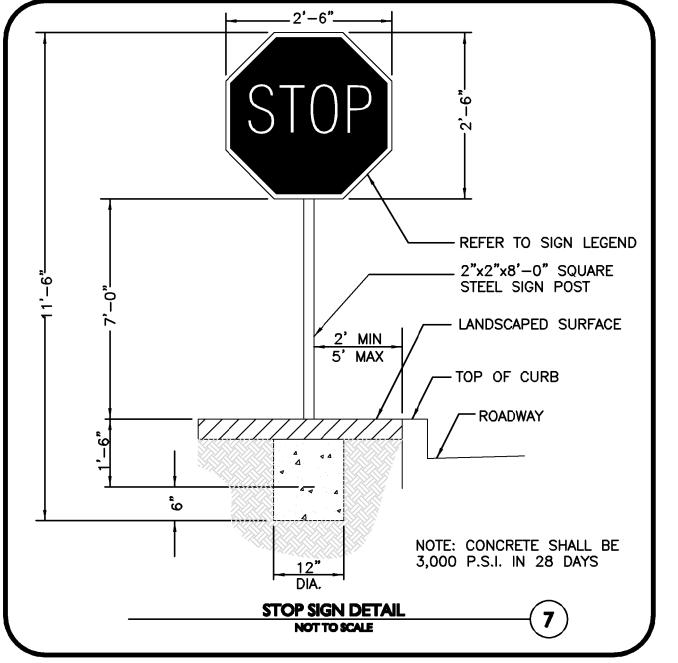


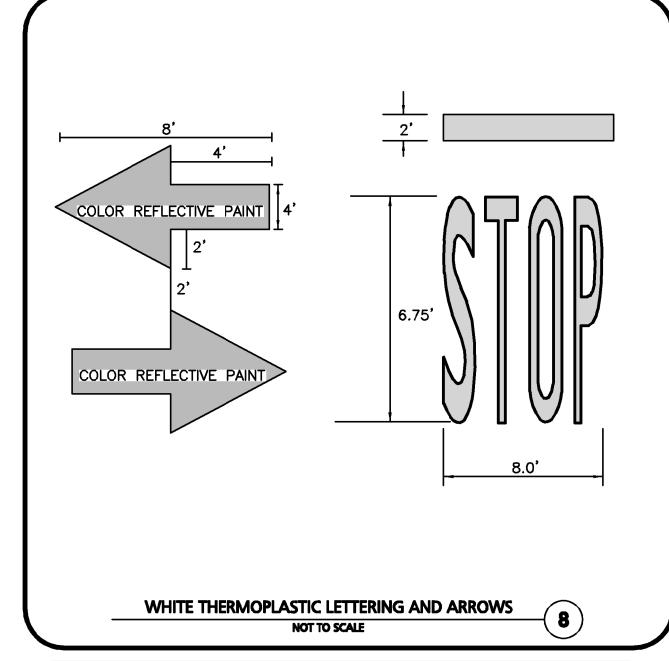


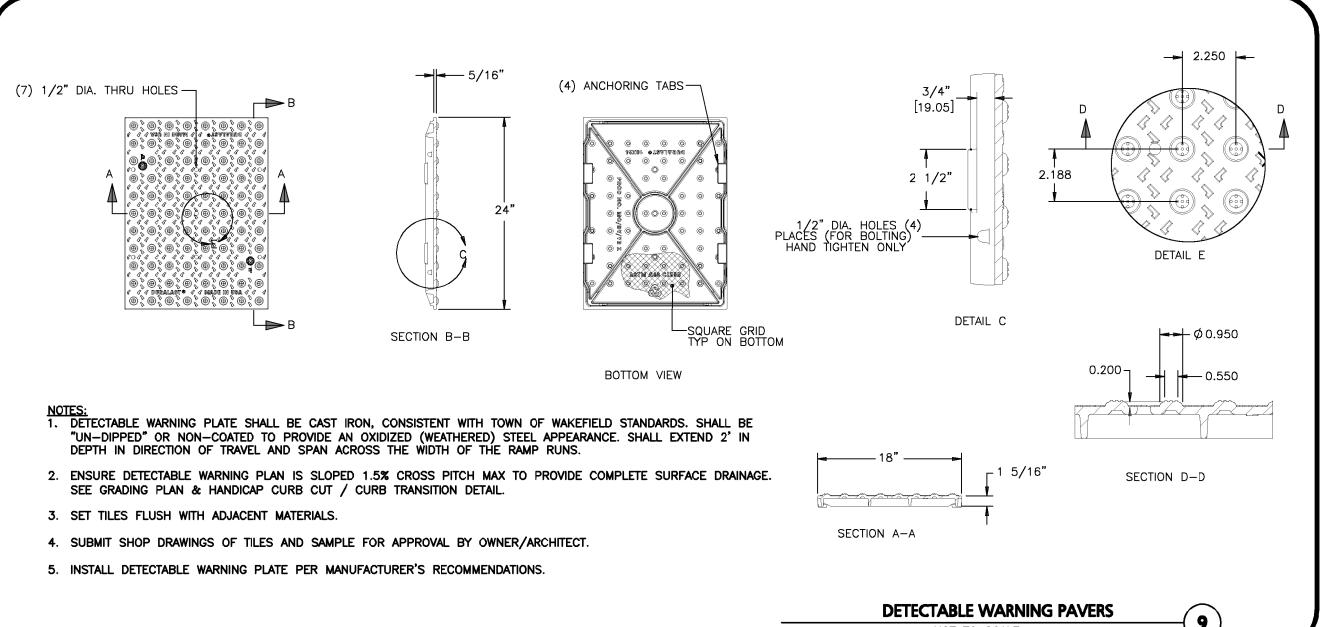


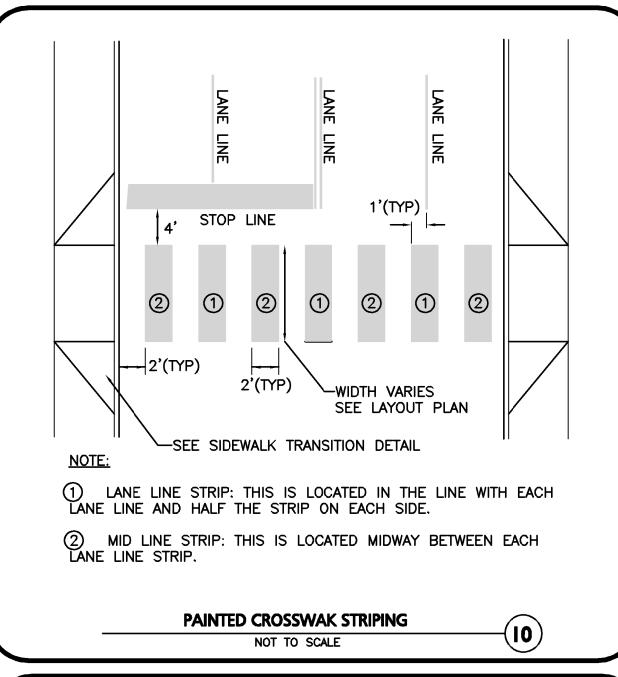


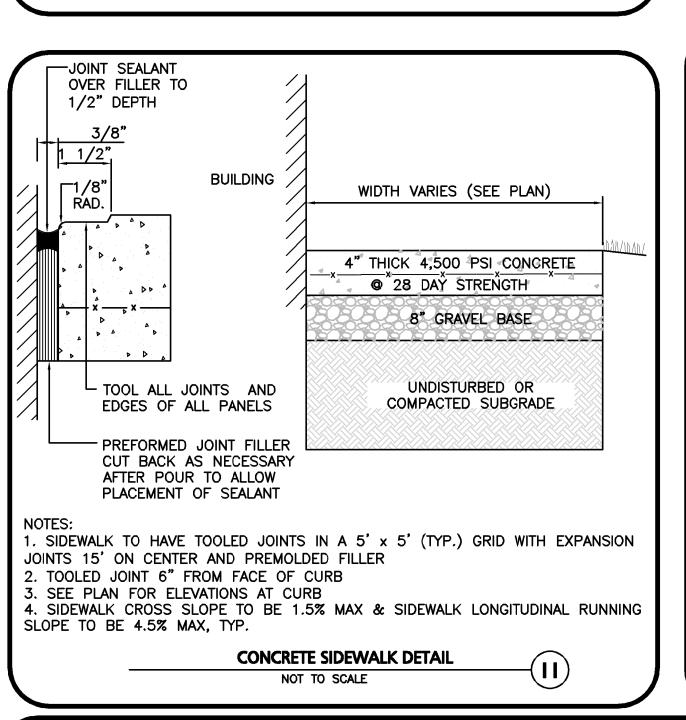


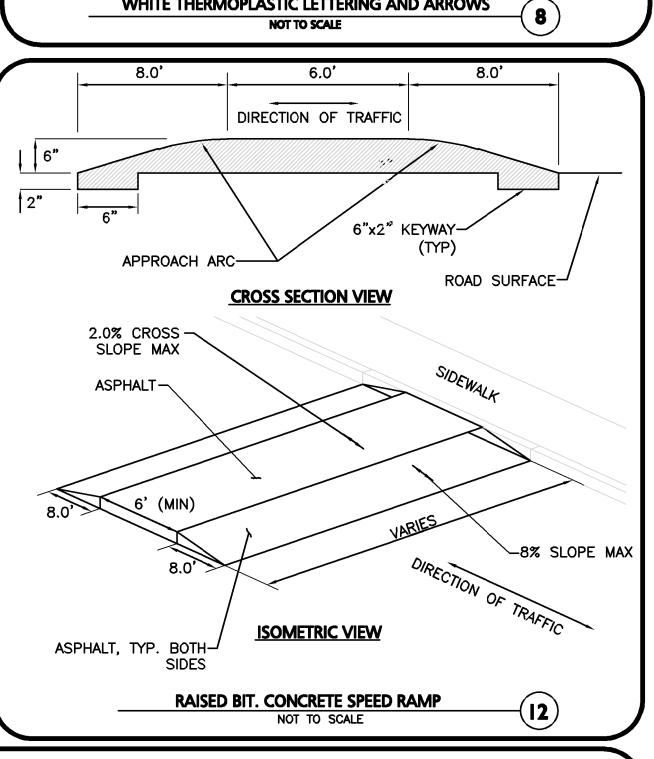


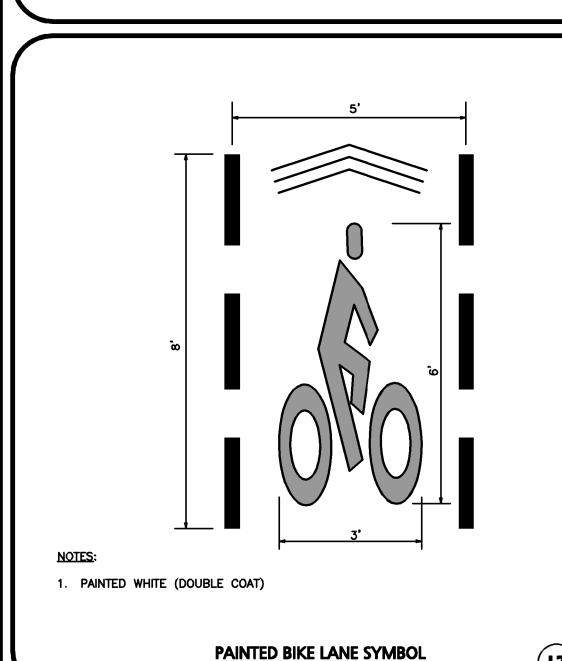

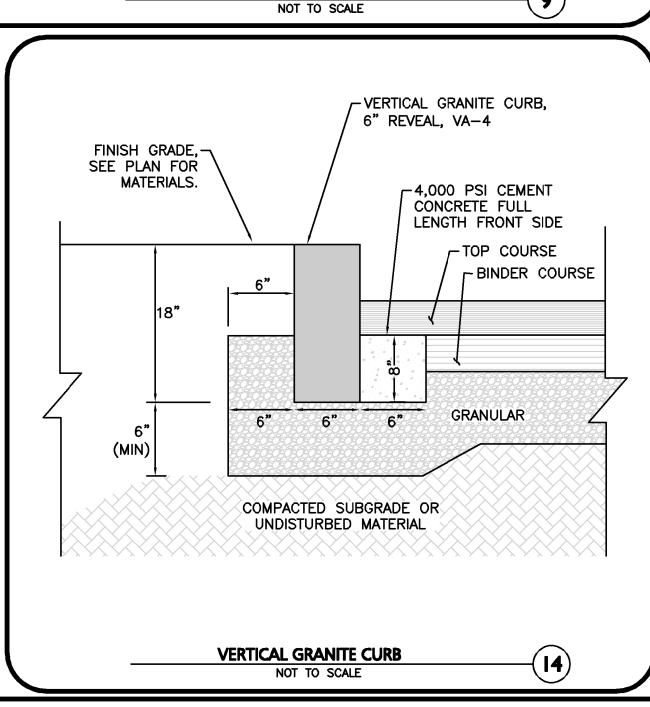

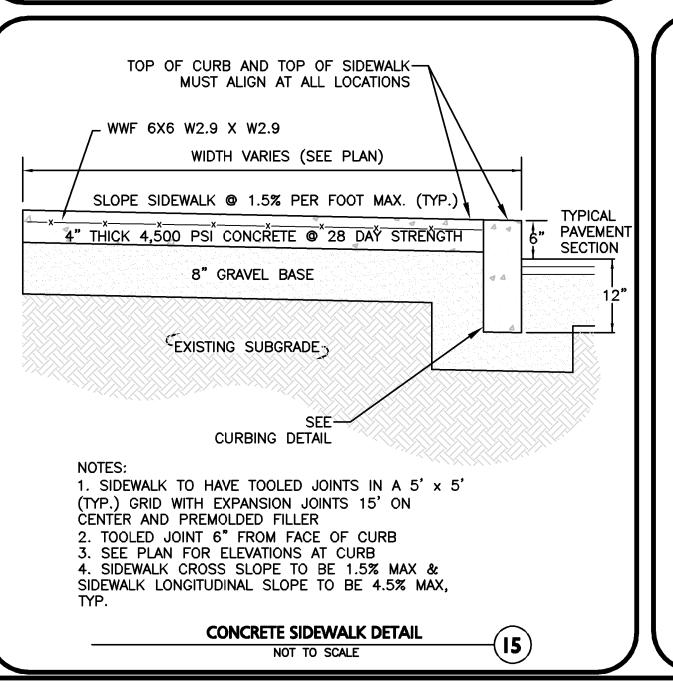

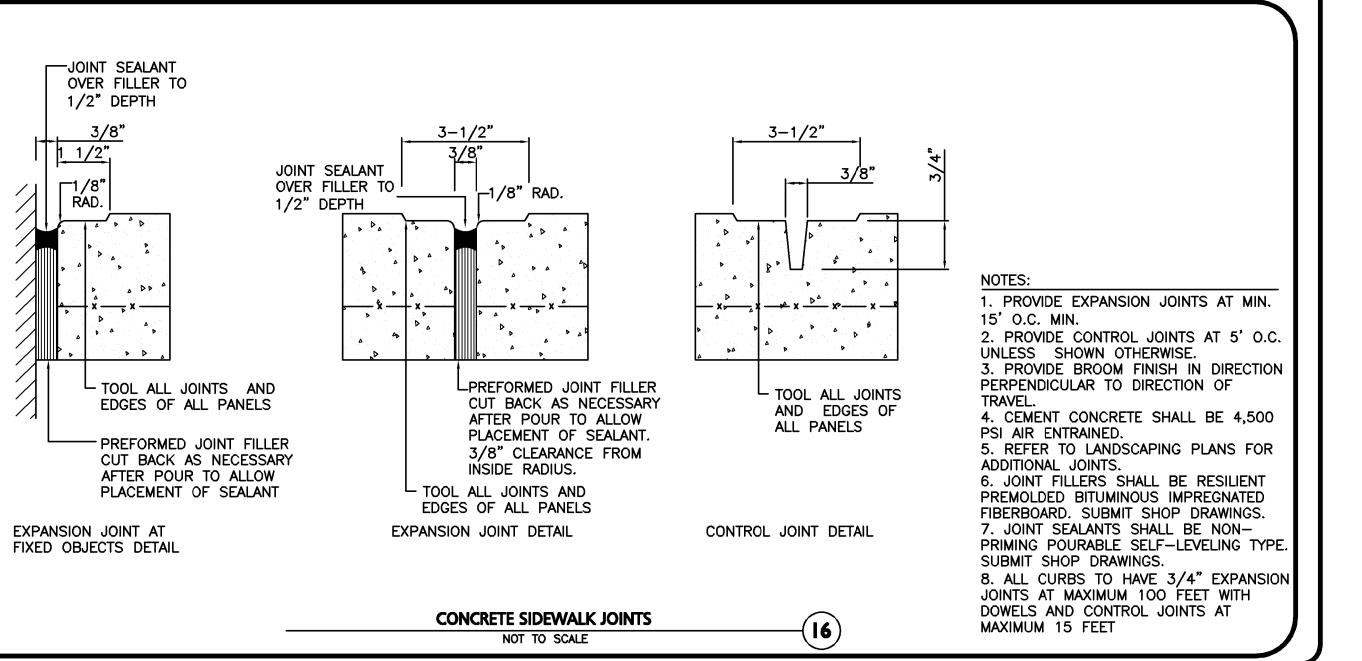

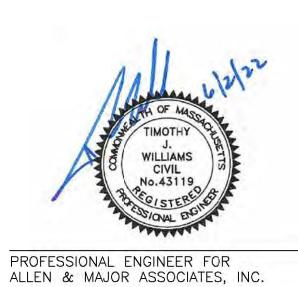

8	06/02/2022	Re-Issued to Con.Com. & ZBA
7	04/08/2022	Re-Issued to Con.Com. & ZBA
6	2/07/2022	Re-Issued to Conservation Commission
5	1/05/2022	Re-Issued to Conservation Commission
4	11/11/2021	Re-Issued to ZBA
3	9/01/2021	Re-Issued to ZBA
2	8/03/2021	Issued to Conservation Commission
1	3/31/2021	Re-Issued to ZBA

CCF QUANNAPOWITT PROPERTY
COMPANY, LLC
185 DARTMOUTH STREET
BOSTON, MA 02116

REV DATE DESCRIPTION

200-400 QUANNAPOWITT PARKWAY WAKEFIELD, MA 01880

PROJECT NO.	1623-11	DATE:	MARCH 16, 20
SCALE:	N.T.S.	DWG. NA	AME: C-1623-11.dv
DESIGNED BY:	NCD	CHECKE	O BY: TJV
PREPARED BY:			



ASSOCIATES, INC.

civil engineering • land surveying
environmental consulting • landscape architecture
w w w . a llenmajor.com

100 COMMERCE WAY
WOBURN MA 01888-0118

TEL: (781) 935-6889
FAX: (781) 935-2896

WOBURN, MA LAKEVILLE, MA MANCHESTER, NH

THIS DRAWING HAS BEEN PREPARED IN DIGITAL FORMAT.

CLIENT/CLIENT'S REPRESENTATIVE OR CONSULTANTS MAY BE
PROVIDED COPIES OF DRAWINGS AND SPECIFICATIONS FOR HIS/HER
INFORMATION AND/OR SPECIFIC USE ON THIS PROJECT. DUE TO THE

POTENTIAL THAT THE PROVIDED INFORMATION MAY BE MODIFIED UNINTENTIONALLY OR OTHERWISE, ALLEN & MAJOR ASSOCIATES, INC. MAY REMOVE ALL INDICATION OF THE DOCUMENT'S AUTHORSHIP ON THE DIGITAL MEDIA. PRINTED REPRESENTATIONS OR PORTABLE DOCUMENT FORMAT OF THE DRAWINGS AND SPECIFICATIONS ISSUED SHALL BE THE ONLY RECORD COPIES OF ALLEN & MAJOR ASSOCIATES, INC.'S WORK PRODUCT.

DRAWING TITLE:


SHEET No.


VING TITLE:

SHEET No.

C-501

Copyright © 2022 Allen & Major Associates, Inc.
All Rights Reserved

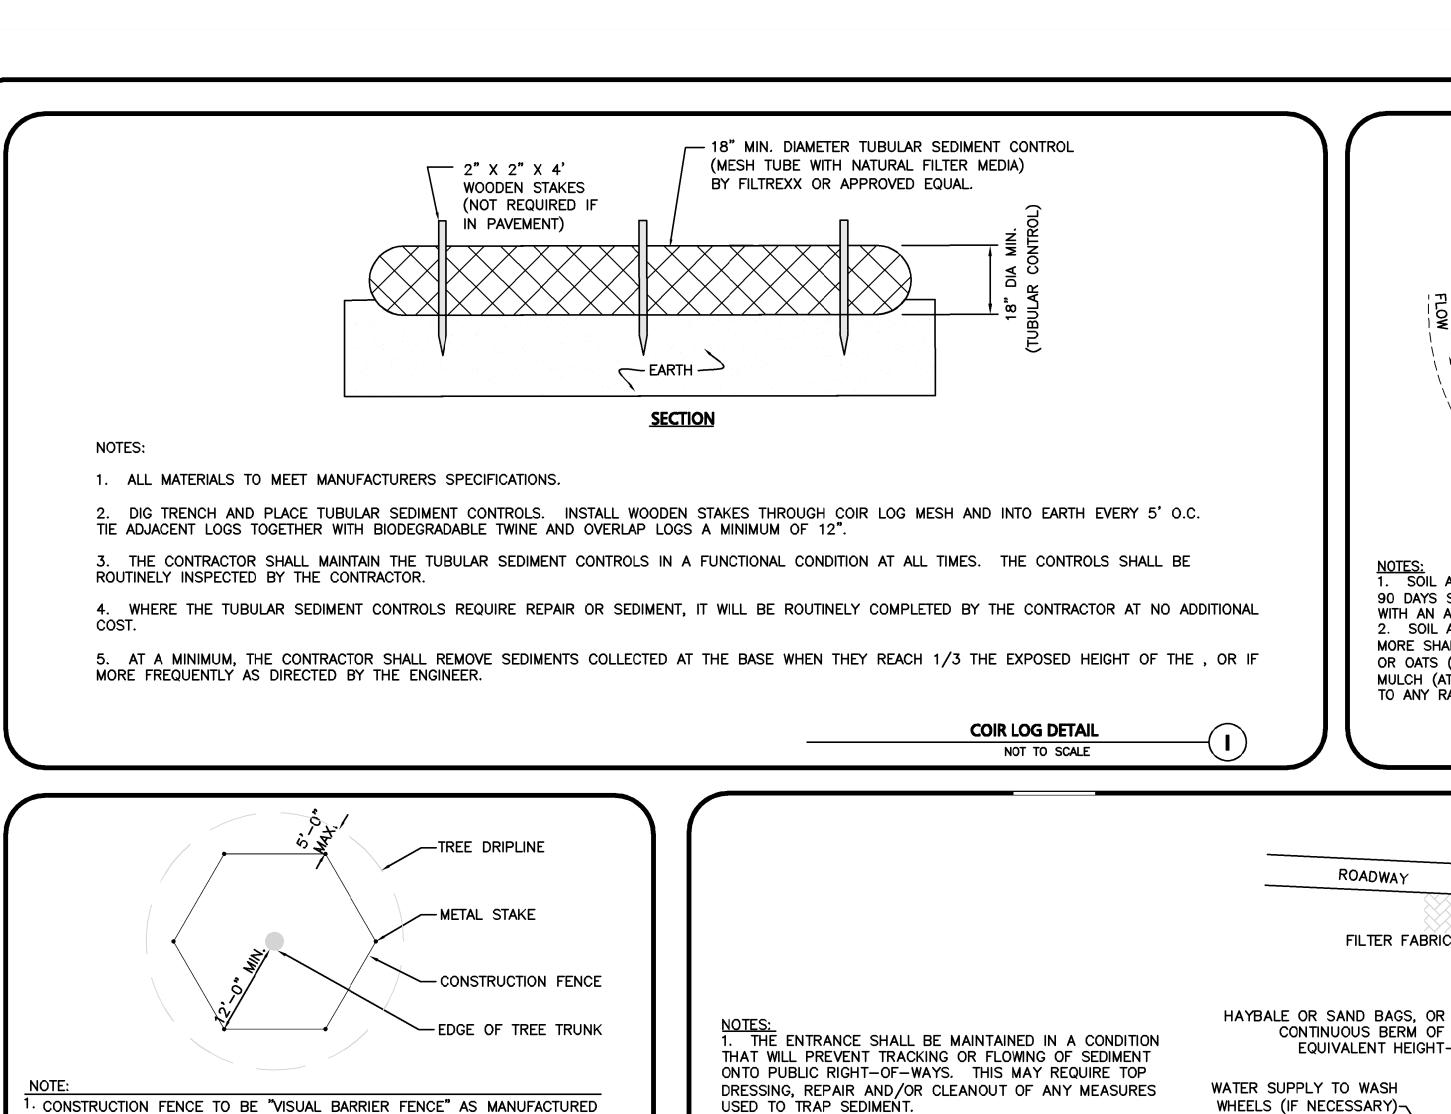

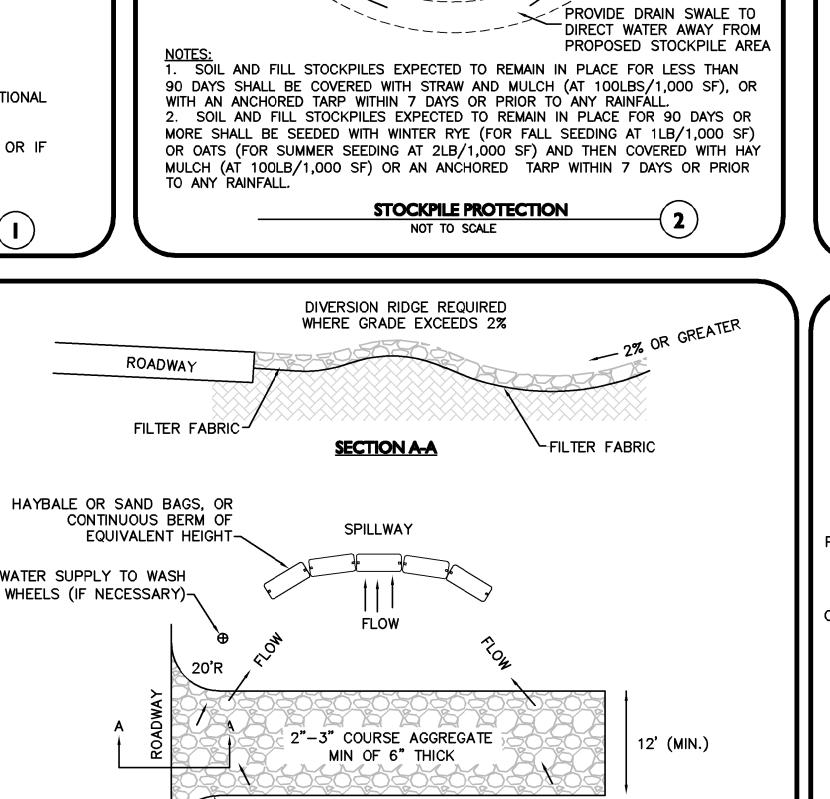

<u>PLAN</u>

TEMPORARY CONSTRUCTION ENTRANCE/EXIT


└DIVERSION RIDGE

PROPOSED STOCKPILE AREA

-EROSION CONTROL BARRIER

INSTALLED DOWN SLOPE OF

PROPOSED STOCKPILE AREA

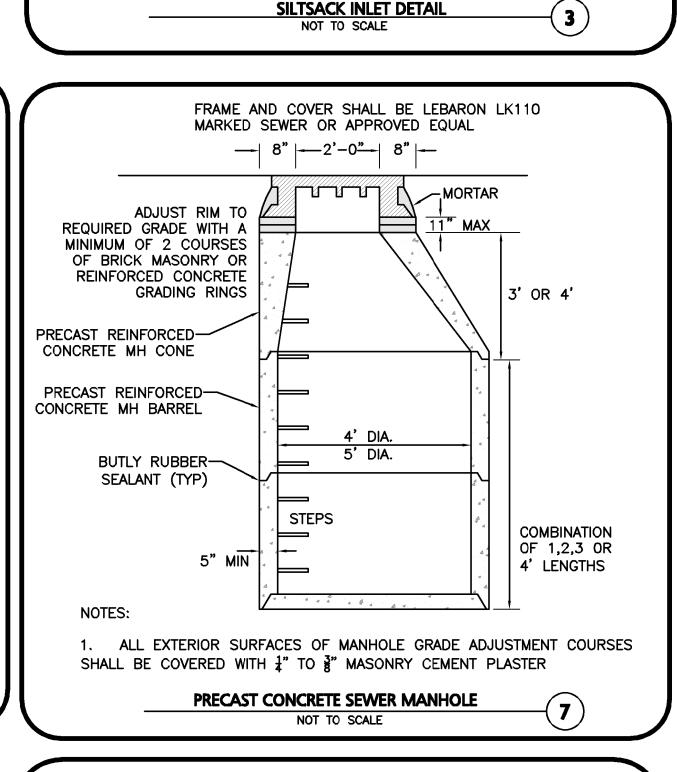

 \Leftrightarrow

 \Diamond

" REBAR FOR LIFTING

─DUMP STRAP (2)

CATCH BASIN STRUCTURE

. INSTALL SILTSACK PER

MANUFACTURER'S INSTRUCTIONS

OR REMOVE SEDIMENT FROM

RINSE, AND REPLACE AS

2. SILT SACKS TO BE INSTALLED

POTENTIAL FOR SEDIMENT TO

ENTER EXISTING & PROPOSED

DURING CONSTRUCTION

OPERATIONS WHEN THE

BASINS EXISTS.

AND RECOMMENDATIONS. EMPTY


SILTSACK WHEN RESTRAINT CORD

IS NO LONGER VISIBLE. CLEAN,

AND REMOVAL

<> `

 \Diamond

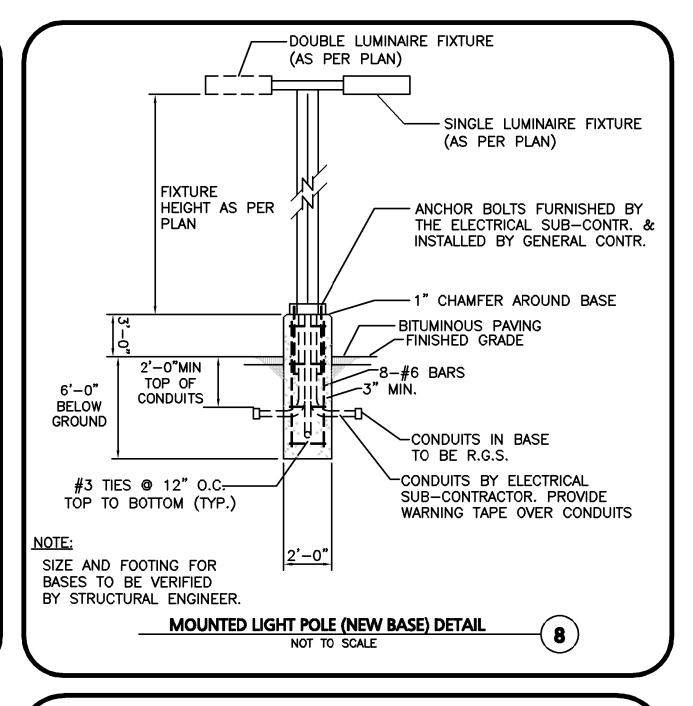

HEIGHT AS PER

EXISTING-

MOUNTED LIGHT POLE (EXISTING BASE) DETAIL

ELECTRICAL

-SINGLE OR DOUBLE

LUMINAIRE FIXTURE

(AS PER PLAN)

-SINGLE LUMINAIRE FIXTURE

-ANCHOR BOLTS FURNISHED BY THE ELECTRICAL CONTR.

& INSTALLED BY GENERAL


(AS PER PLAN)


-EXISTING BASE


FINISH GRADE


ELECTRICAL


CONDUIT

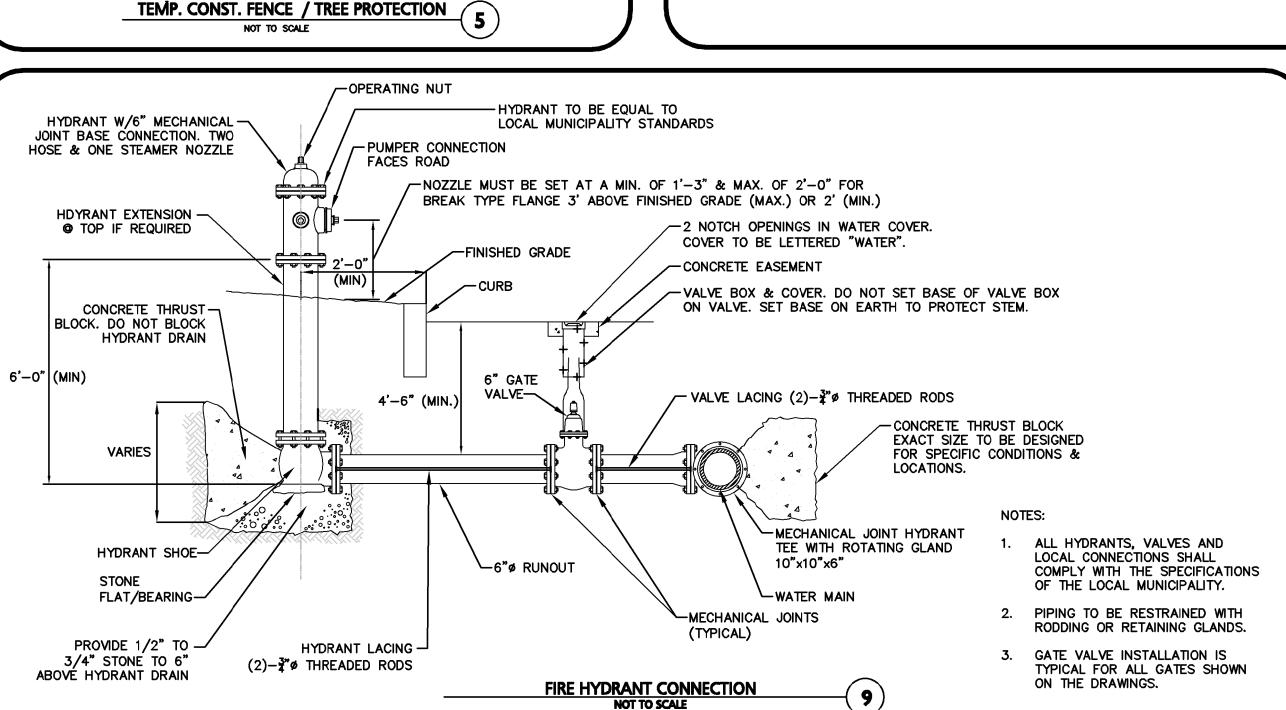

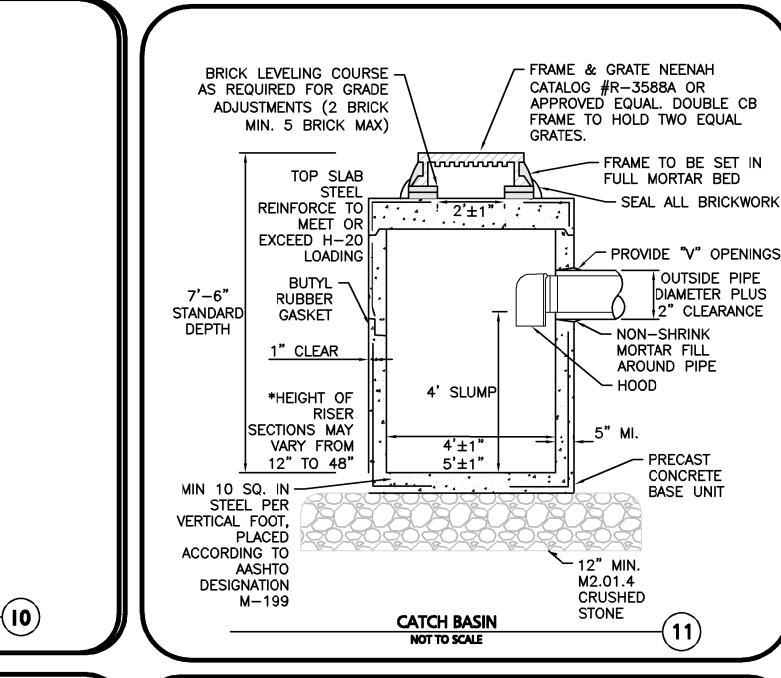

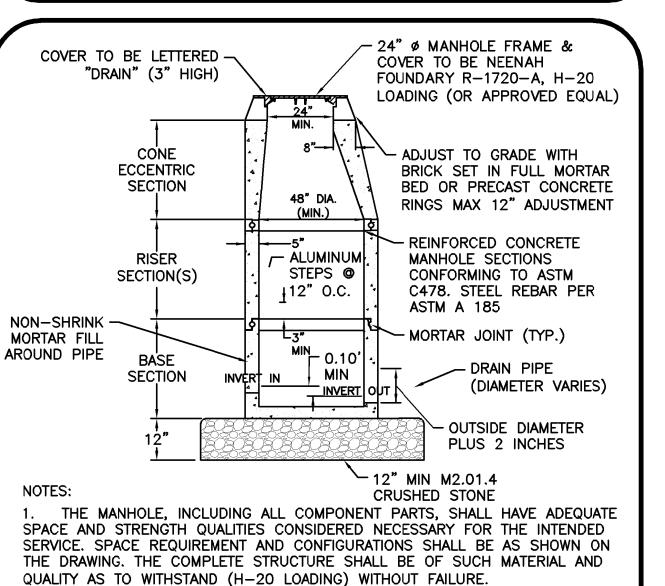

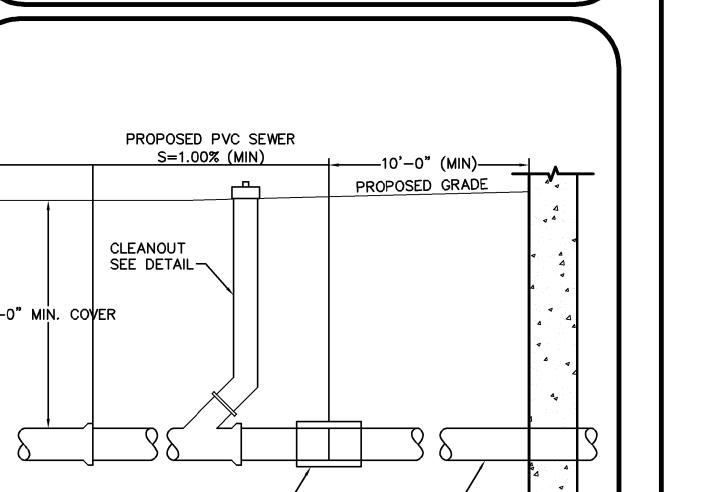

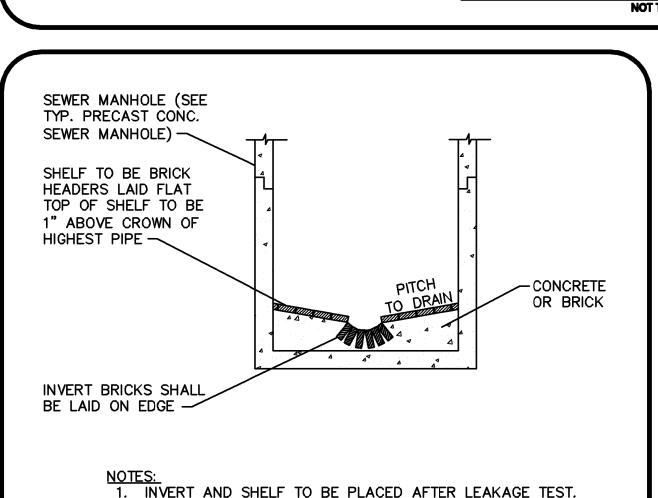

2. MANHOLES SHALL HAVE A BRICK PAVED SHELF AND INVERT,

TO DRAIN TOWARD THE FLOWING THROUGH CHANNEL.

TYPICAL BRICK INVERT SECTION FOR SEWER MANHOLES (13)

NOT TO SCALE

CEMENT CONCRETE OR BRICK IN MORTAR.

CONSTRUCTED TO CONFORM TO THE SIZE OF PIPE AND FLOW.

AT CHANGES IN DIRECTION, THE INVERTS SHALL BE LAID OUT

IN CURVES OF THE LONGEST RADIUS POSSIBLE TANGENT TO

THE CETER LINE OF THE HIGHEST PIPE CROWN AND SLOPE

UNDERLAYMENT OF INVERT AND SHELF SHALL CONSIST OF

BY EXXON CHEMICAL COMPANY ATLANTA, GA; "KONTROL SAFETY FENCE" AS

METAL POSTS

CONSTRUCTION


MANUFACTURED BY MIRAFI, CHARLOTTE, N.C. OR APPROVED EQUAL.


2. IF GROUPS OF TREES ARE TO BE PROTECTED, EXTEND FENCE AROUND


PERIMETER TO CONFORM TO MINIMUM DIMENSIONS FOR TREE


6' 0.C. (TYP.)

TRUNKS AND DRIPLINE.

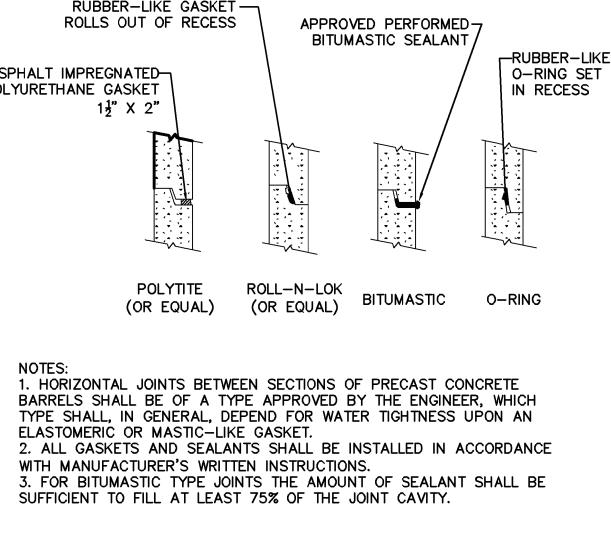


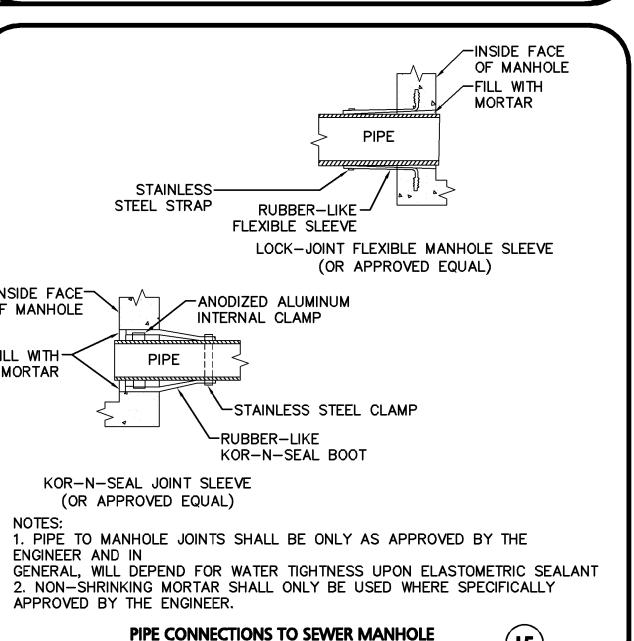

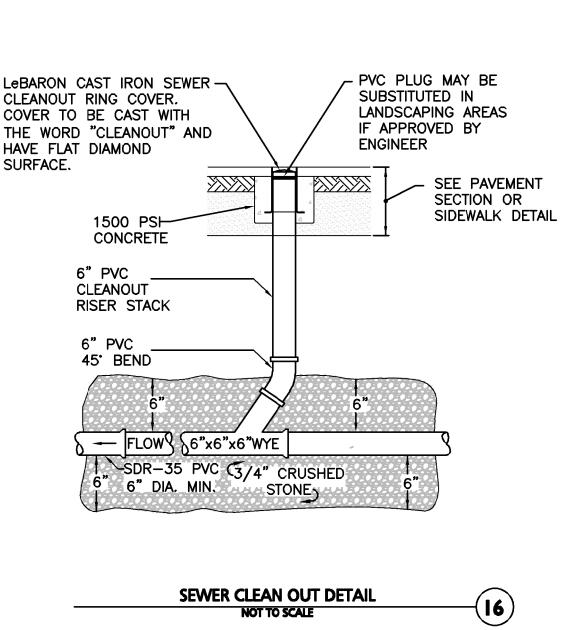

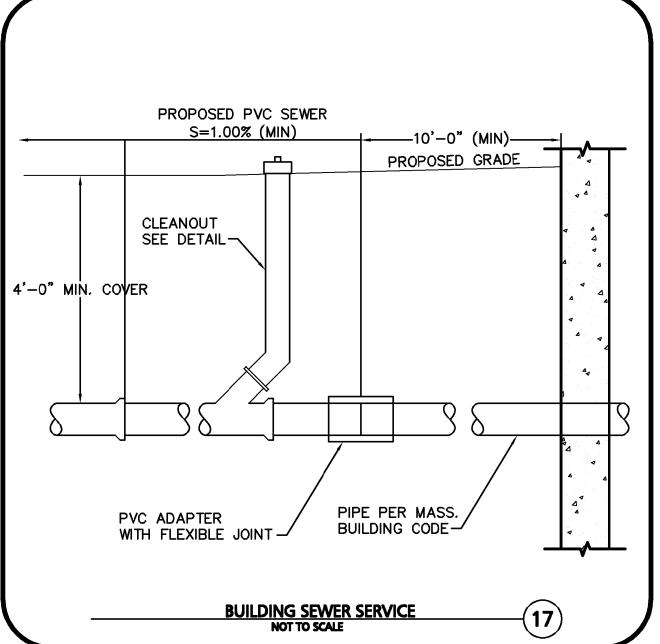

PRECAST DRAIN MANHOLE

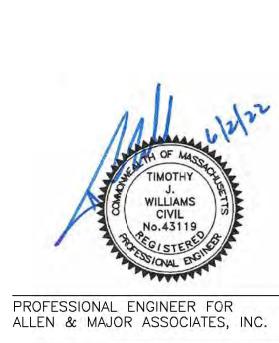


8	06/02/2022	Re-Issued to Con.Com. & ZBA
7	04/08/2022	Re-Issued to Con.Com. & ZBA
6	2/07/2022	Re-Issued to Conservation Commission
5	1/05/2022	Re-Issued to Conservation Commission
4	11/11/2021	Re-Issued to ZBA
3	9/01/2021	Re-Issued to ZBA
2	8/03/2021	Issued to Conservation Commission
1	3/31/2021	Re-Issued to ZBA
REV	DATE	DESCRIPTION

APPLICANT: CCF QUANNAPOWITT PROPERTY COMPANY, LLC **185 DARTMOUTH STREET** BOSTON, MA 02116

200-400 QUANNAPOWITT **PARKWAY** WAKEFIELD, MA 01880

1623-11	DATE:	MARCH	16, 202
N.T.S.	DWG. NA	AME: C-162	3-11.dw
NCD	CHECKED	BY:	/LT
	N.T.S.		N.T.S. DWG. NAME: C-162

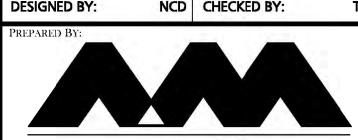




civil engineering ◆ land surveying environmental consulting ♦ landscape architecture www.allenmajor.com 100 COMMERCE WAY WOBURN MA 01888-0118

TEL: (781) 935-6889 FAX: (781) 935-2896 WOBURN, MA ♦ LAKEVILLE, MA ♦ MANCHESTER, N THIS DRAWING HAS BEEN PREPARED IN DIGITAL FORMAT CLIENT/CLIENT'S REPRESENTATIVE OR CONSULTANTS MAY B PROVIDED COPIES OF DRAWINGS AND SPECIFICATIONS FOR HIS/HER INFORMATION AND/OR SPECIFIC USE ON THIS PROJECT. DUE TO THE

UNINTENTIONALLY OR OTHERWISE, ALLEN & MAJOR ASSOCIATES NC. MAY REMOVE ALL INDICATION OF THE DOCUMENT AUTHORSHIP ON THE DIGITAL MEDIA. PRINTED REPRESENTATIONS OR PORTABLE DOCUMENT FORMAT OF THE DRAWINGS AND SPECIFICATIONS ISSUED SHALL BE THE ONLY RECORD COPIES OF ALLEN & MAJOR ASSOCIATES, INC.'S WORK PRODUCT. DRAWING TITLE:

POTENTIAL THAT THE PROVIDED INFORMATION MAY BE MODIFIED

C-502 DETAILS Copyright ©2022 Allen & Major Associates, Inc.
All Rights Reserved

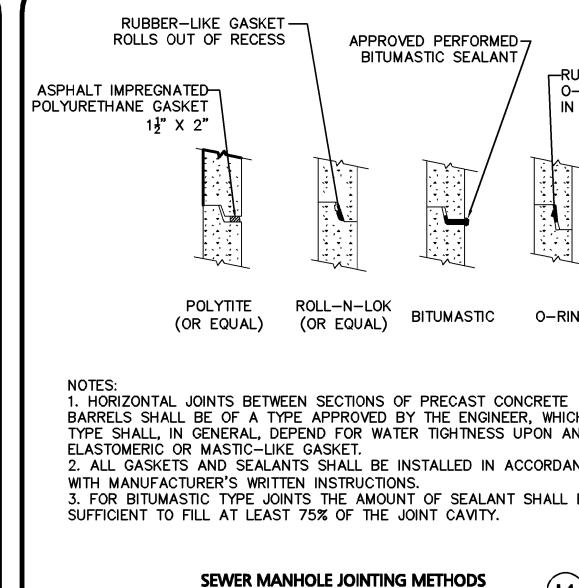

WHEN NECESSARY, WHEELS SHALL BE CLEANED PRIOR

WHEN WASHING IS REQUIRED, IT SHALL BE DONE ON AN


AREA STABILIZED WITH CRUSHED STONE THAT DRAINS INTO

METHODS TO CHANNELIZE RUNOFF TO BASIN AS REQUIRED.

AN APPROVED SEDIMENT TRAP OR SEDIMENT BASIN.


4. USE SANDBAGS, HAYBALES, OR OTHER APPROVED

TO ENTERING THE PUBLIC RIGHT-OF-WAY.

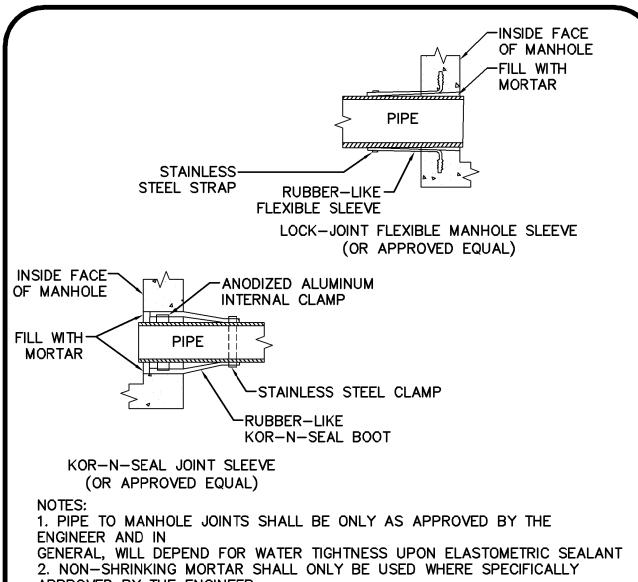

NOT USED

PIPE CONNECTIONS TO SEWER MANHOLE

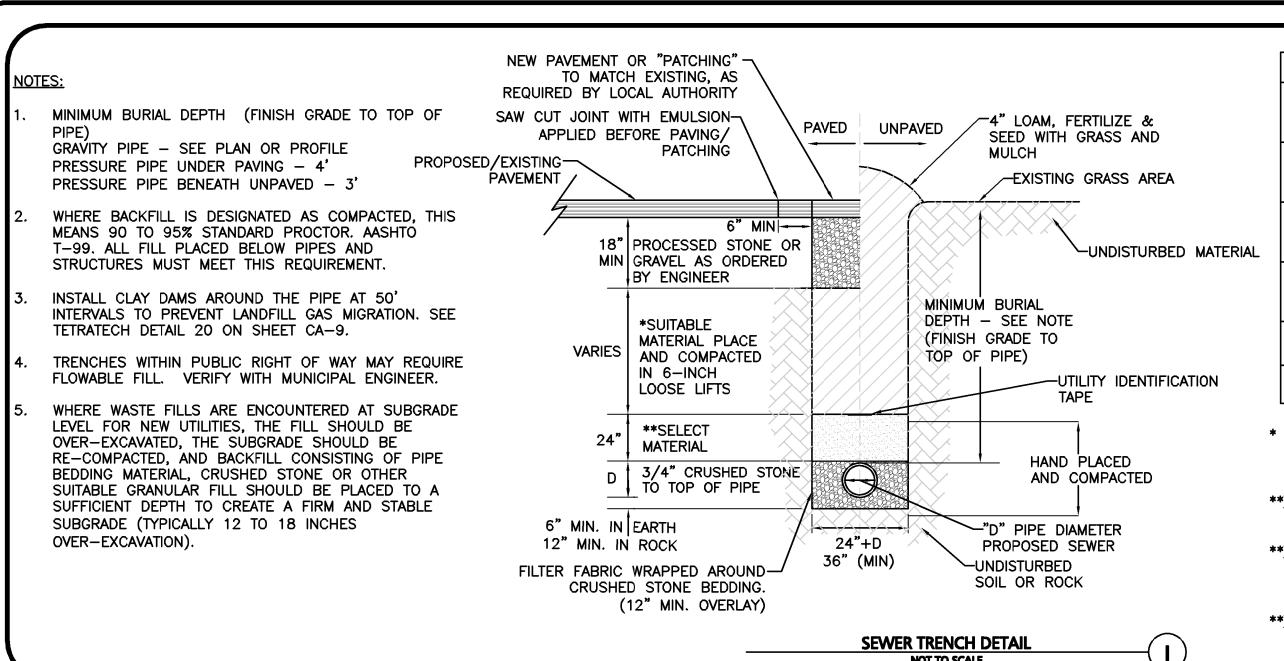

THESE BALES NOT-SHOWN IN VIEW LOOKING UPSTREAM


CONDITION & PIPE	**SELECT MATERIAL	LINING MATERIAL
DUCTILE IRON "ORDINARY SOIL"	TYPE I, II, OR III	SAND OR TYPE II
RCP "ORDINARY SOIL"	TYPE II OR III	SAND OR TYPE II
ALL PIPE OVER BEDROCK OR LEDGE	TYPE II OR III	SAND OR TYPE II
DUCTILE IRON IN CLAY OR MUCK	TYPE II OR III	SAND
RCP IN CLAY	TYPE II OR III	SAND
ALL PLASTICS	TYPE III	SAND OR TYPE II


4" IN DIAMETER, NO FROZEN LUMPS, AND SMALL AMOUNTS OF CLAY OR ORGANIC MATERIAL. ALL MATERIAL TO BE PLACED IN MAX 12" LIFTS AND COMPACTED BEFORE PLACING NEXT LIFT.

**TYPE I MATERIAL SHALL BE EITHER GRAVEL OR EXCAVATED MATERIAL CONTAINING NO STONES GREATER THAN 1.5" DIAMETER, NO FROZEN LUMPS, CLAY OR ORGANIC MATERIAL.

**TYPE II MATERIAL SHALL BE CLEAN, HARD, CRUSHED OR NATURAL STONE WITH A GRADATION BY WEIGHT OF 100% PASSING A 1.5" SQUARE OPENING, NOT MORE THAN 25% PASSING A ₹" OPENING, AND NOT MORE THAN 5% PASSING A 3" SQUARE OPENING.

**TYPE III MATERIAL SHALL BE CLEAN, HARD, CRUSHED STONE FREE FROM COATINGS AND THOROUGHLY WASHED WITH A GRADATION BY WEIGHT OF 100% PASSING A 3/4" SQUARE OPENING, AND 0 TO 5% PASSING A 1 SQUARE OPENING.

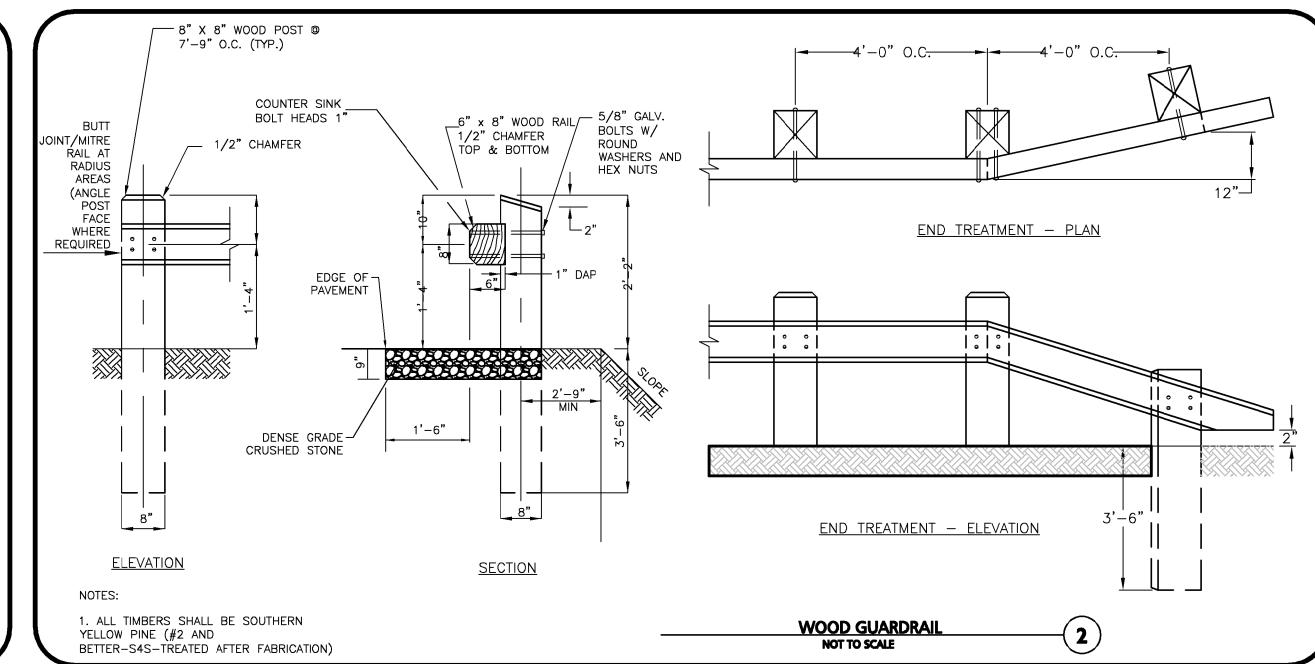

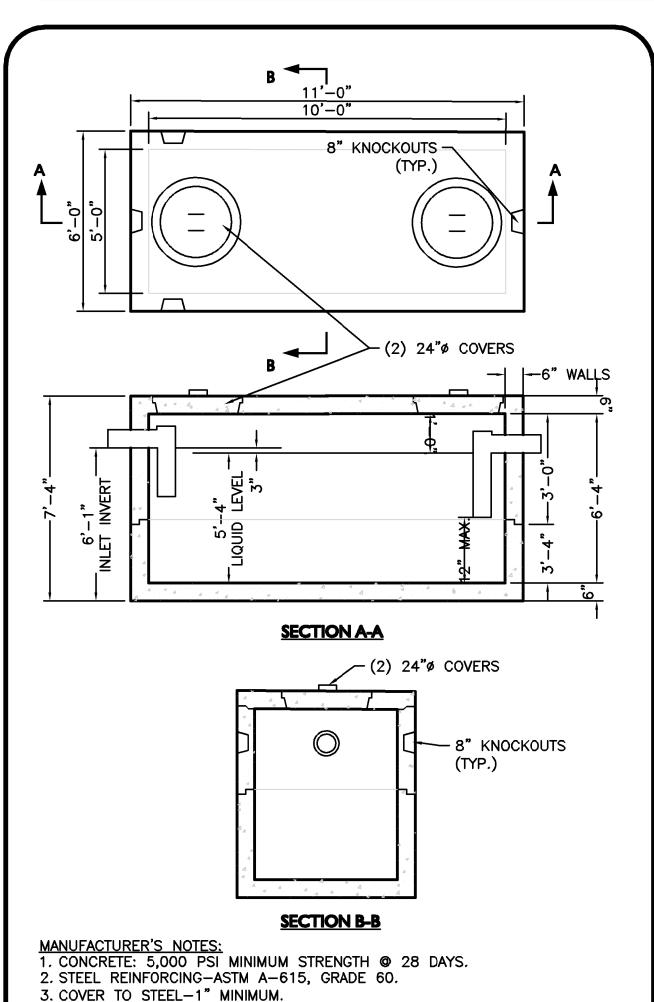

4. TANKS ARE DESIGNED TO MEET ASTM C858 AND ACI 318 WITH ASSHTO

6. CONSTRUCTION JOINT SEALED WITH 1" DIA. BUTYL RUBBER OR EQUIVILENT.

7. APPROX. WEIGHTS: TOP SLAB = 2.3 TONS; BOTTON SECTION = 8.5 TONS.

STRUCTURE, INCLUDING THE 4" VENT PIPE, SHALL BE THE RESPONSIBILITY

1. ALL PIPE GOING TO, WITHIN, AND TO 10 FEET BEYOND THE CONCRETE

2. ALL PIPE, INCLUDING THE 4" VENT PIPE TO THE ROOF, SHALL BE CAST

3. THE PLUMBING PROFESSIONAL SHOULD COORDINATE INSTALLATION OF THE

4. ADJUST TO GRADE WITH MINIMUM 12" OF CONCRETE BRICK AND MORTAR

NOT TO SCALE

5. BUTYL RUBBER JOINT SEALANT SHALL BE USED AT ALL JOINTS.

TANK, ACCESS MANHOLES, AND DETAILS OF EXCAVATION, BACKFILLING, AND

2,000 GALLON PRECAST CONCRETE GREASE TRAP (3)


HS-20 LOADING.

5. EARTH COVER: 0 TO 5 FEET MAX.

OF THE PLUMBING PROFESSIONAL.


(RED BRICK SHALL NOT BE USED).


WATERPROOFING WITH THE CIVIL ENGINEER.

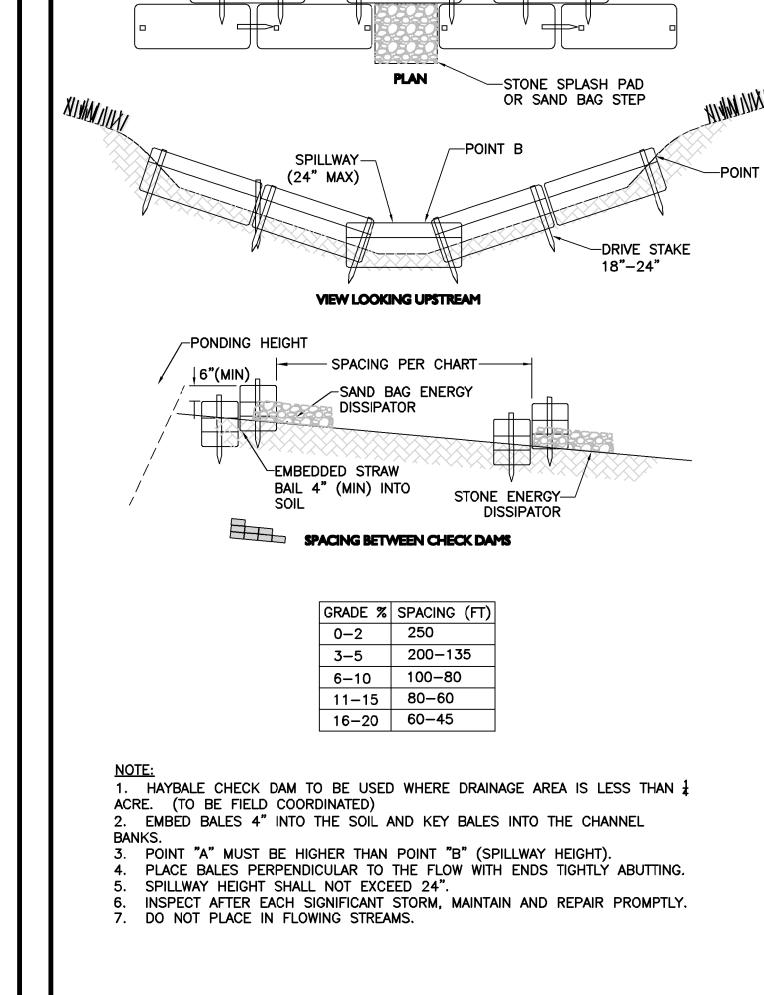

NOT TO SCALE

SPILLWAY

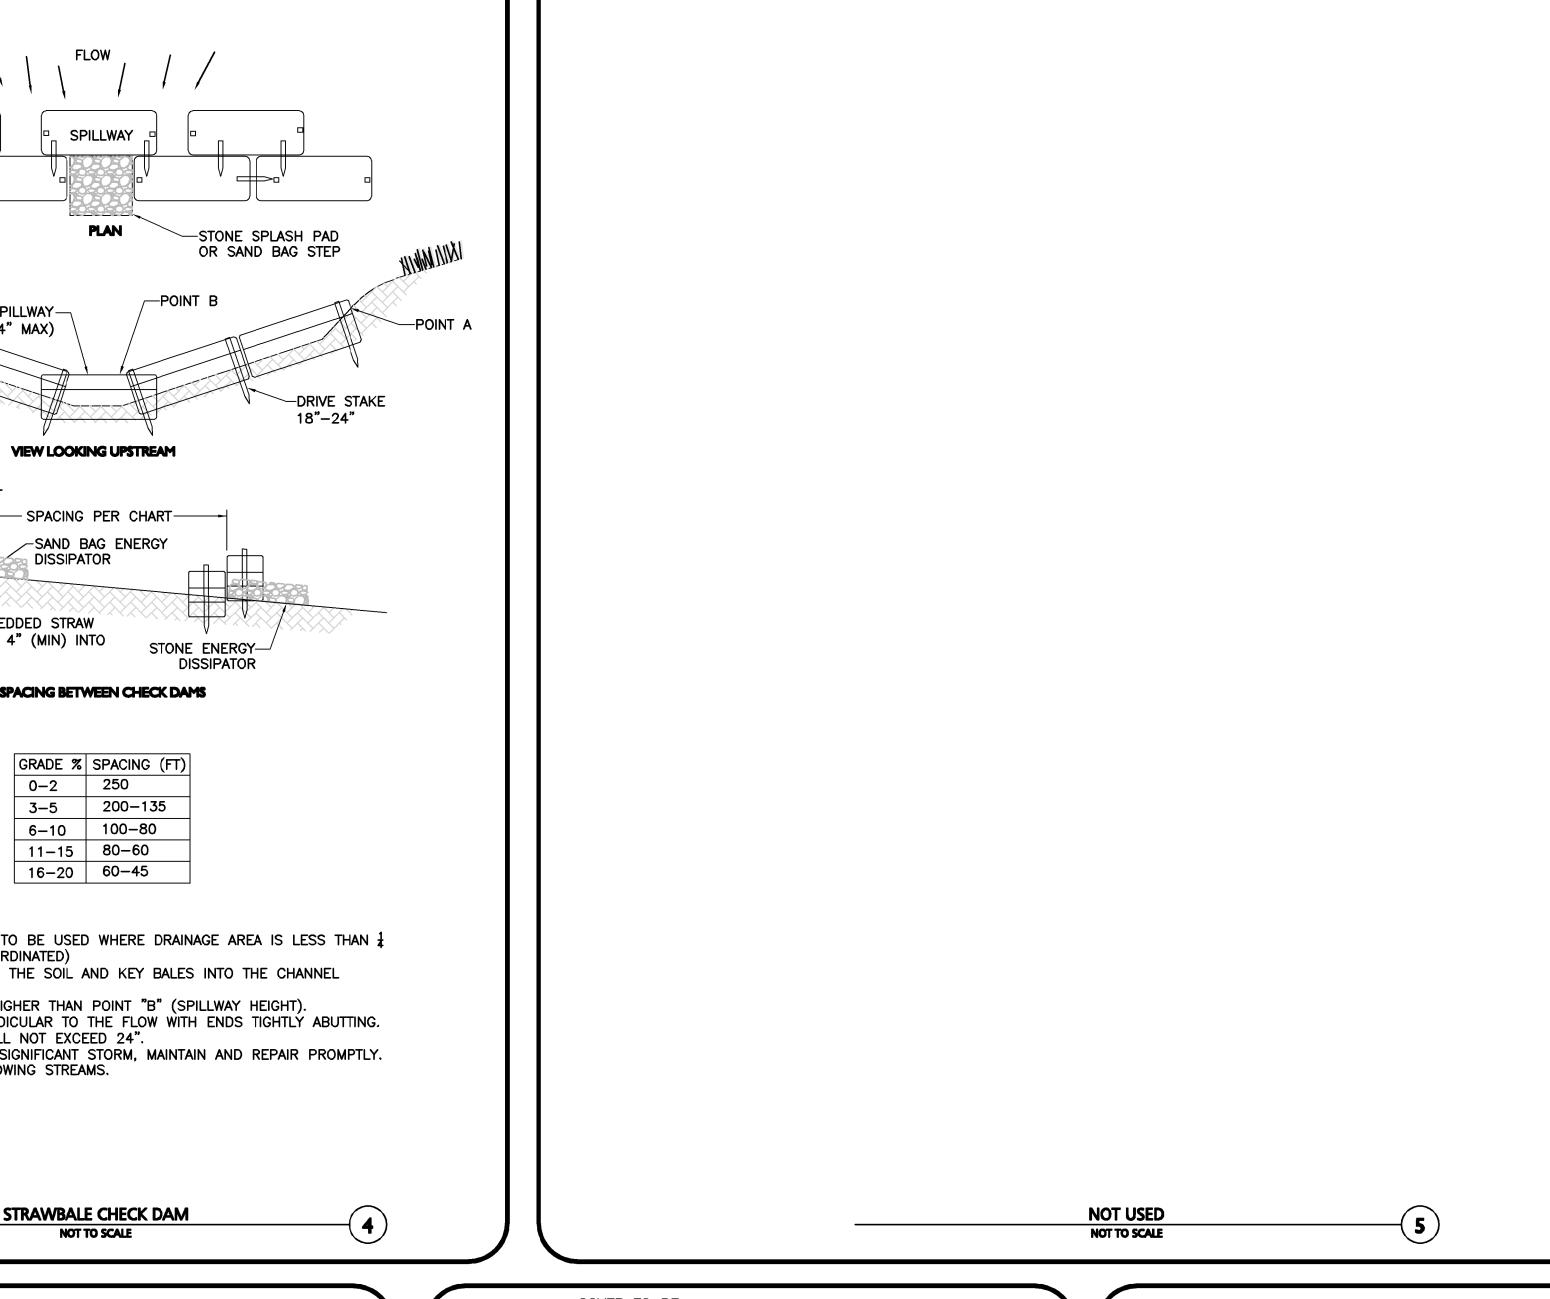

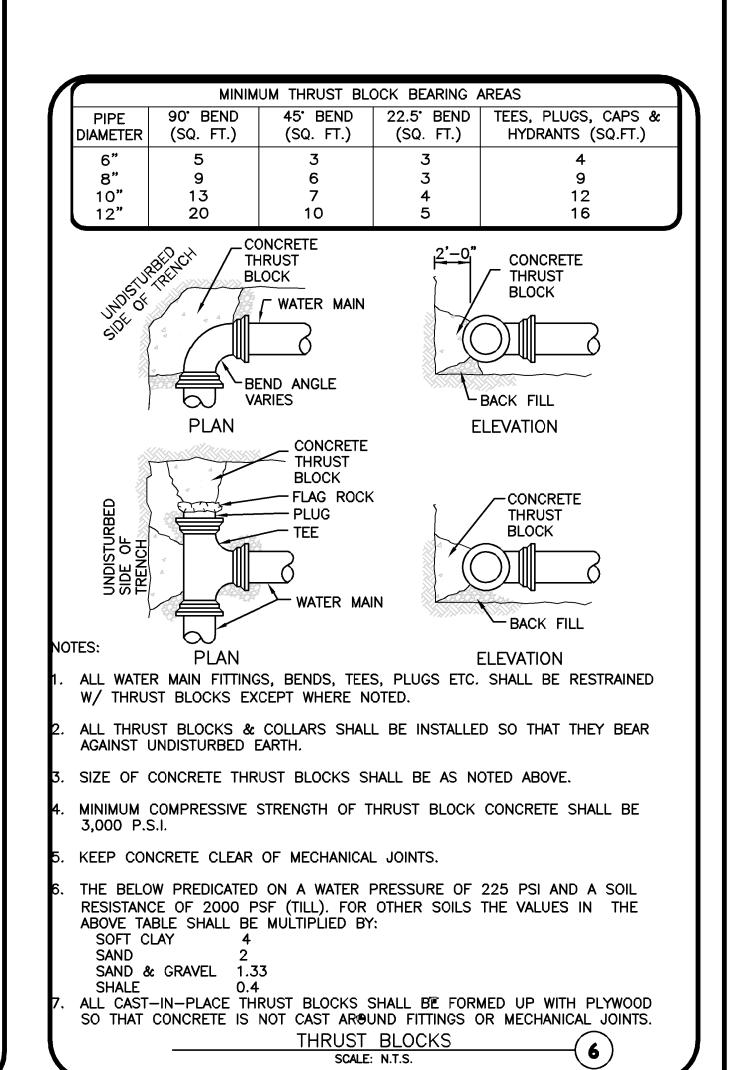

WATER MAIN

BETWEEN A SEWER MAIN AND A WATER MAIN:

MAIN SHALL BE AT LEAST 18 INCHES.

THE CROSSING.

SEPARATION FROM THE POINT OF CROSSING.

WHENEVER CONDITIONS PREVENT A LATERAL SEPARATION OF 10 FEET

. THE WATER MAIN SHALL BE LAID IN A SEPARATE TRENCH AND THE

3. THE PIPE JOINTS SHALL BE STAGGERED TO PROVIDE THE MAXIMUM

DIFFERENCE IN ELEVATION BETWEEN THE WATER MAIN AND THE SEWER

2. THE PIPE CROSSING SHALL OCCUR AS CLOSE TO 90° AS PRACTICABLE.

4. THE CROSSING SHALL BE ENCASED IN CONCRETE FOR THE ENTIRE WIDTH

OF THE TRENCH AND FOR A DISTANCE OF 8 LINEAR FEET CENTERED ON

SEWER / WATER CROSSING DETAIL


NOT TO SCALE

(DIAMETER VARIES)

8' (MINIMUM)

✓ 4

♥

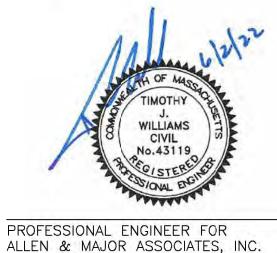

06/02/2022 Re-Issued to Con.Com. & ZBA 04/08/2022 Re-Issued to Con.Com. & ZBA 2/07/2022 | Re-Issued to Conservation Commission 1/05/2022 | Re-Issued to Conservation Commission 4 | 11/11/2021 | Re-Issued to ZBA 9/01/2021 Re-Issued to ZBA


8/03/2021 Issued to Conservation Commission

3/31/2021 Re-Issued to ZBA REV DATE DESCRIPTION APPLICANT:

CCF QUANNAPOWITT PROPERTY COMPANY, LLC **185 DARTMOUTH STREET** BOSTON, MA 02116

200-400 QUANNAPOWITT **PARKWAY** WAKEFIELD, MA 01880

	PROJECT NO.	1623-11	DATE:	MARCH	1 16, 20
	SCALE:	N.T.S.	DWG. NAME: C-1623-11		23-11.d
	DESIGNED BY:	NCD	CHECKE	BY:	Т

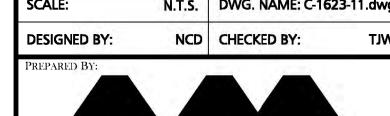




ASSOCIATES, INC.


civil engineering ◆ land surveying environmental consulting • landscape architecture www.allenmajor.com 100 COMMERCE WAY WOBURN MA 01888-0118


TEL: (781) 935-6889 FAX: (781) 935-2896 WOBURN, MA ♦ LAKEVILLE, MA ♦ MANCHESTER. NI

THIS DRAWING HAS BEEN PREPARED IN DIGITAL FORMAT CLIENT/CLIENT'S REPRESENTATIVE OR CONSULTANTS MAY BE PROVIDED COPIES OF DRAWINGS AND SPECIFICATIONS FOR HIS/HER INFORMATION AND/OR SPECIFIC USE ON THIS PROJECT. DUE TO THE POTENTIAL THAT THE PROVIDED INFORMATION MAY BE MODIFIED UNINTENTIONALLY OR OTHERWISE, ALLEN & MAJOR ASSOCIATES, NC. MAY REMOVE ALL INDICATION OF THE DOCUMENT'S AUTHORSHIP ON THE DIGITAL MEDIA. PRINTED REPRESENTATIONS OR PORTABLE DOCUMENT FORMAT OF THE DRAWINGS AND SPECIFICATIONS ISSUED SHALL BE THE ONLY RECORD COPIES OF ALLEN & MAJOR ASSOCIATES, INC.'S WORK PRODUCT.

DRAWING TITLE: C-503 DETAILS Copyright ©2022 Allen & Major Associates, Inc.
All Rights Reserved

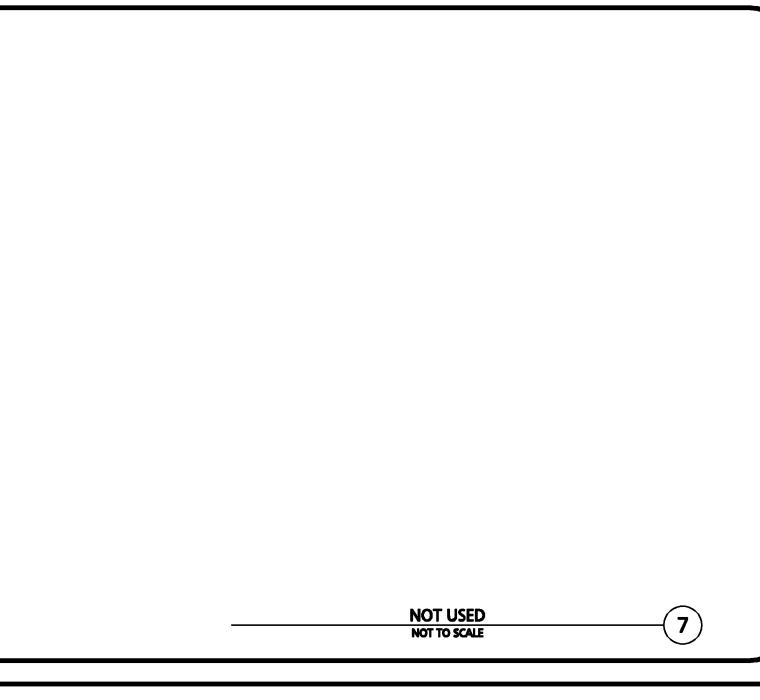

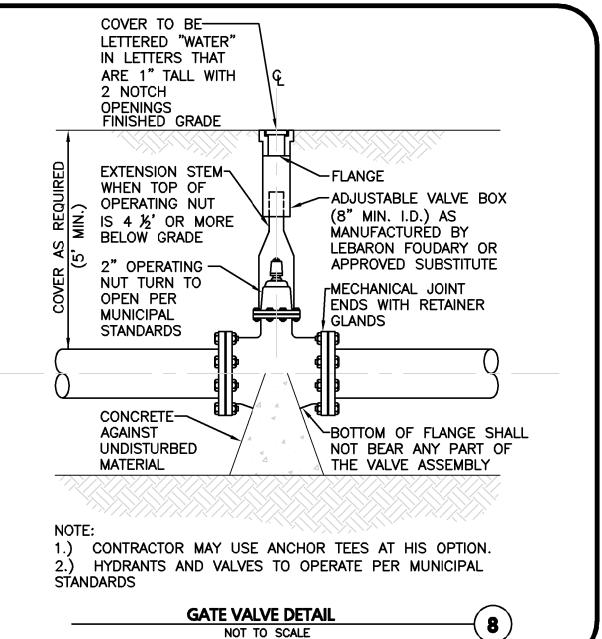

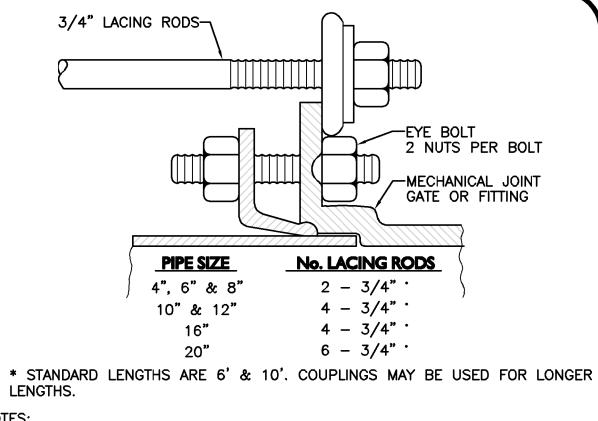


1. NUMBER OF LACING RODS IS BASED ON MAXIMUM PRESSURE OF 125 P.S.I.


2. EYE-BOLTS AND LACING RODS ARE TO BE FABRICATED FROM A-36 STEEL.


36,000 P.S.I. 4. EYE-BOLTS SHALL HAVE A MINIMUM TENSILE STRENGTH OF 7,000 LBS. EACH.


3. STEEL LACING RODS SHALL HAVE A YIELD STRESS OF NOT LESS THAN


MECHANICAL JOINT LACING DETAIL NOT TO SCALE

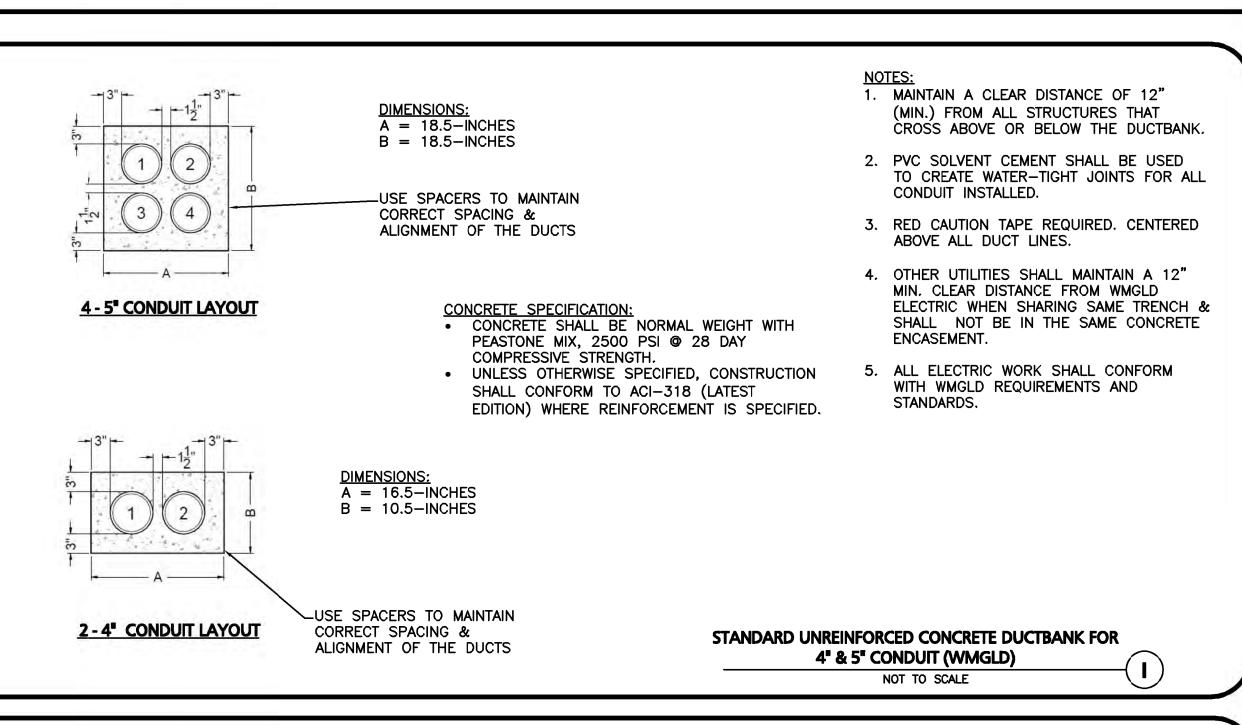


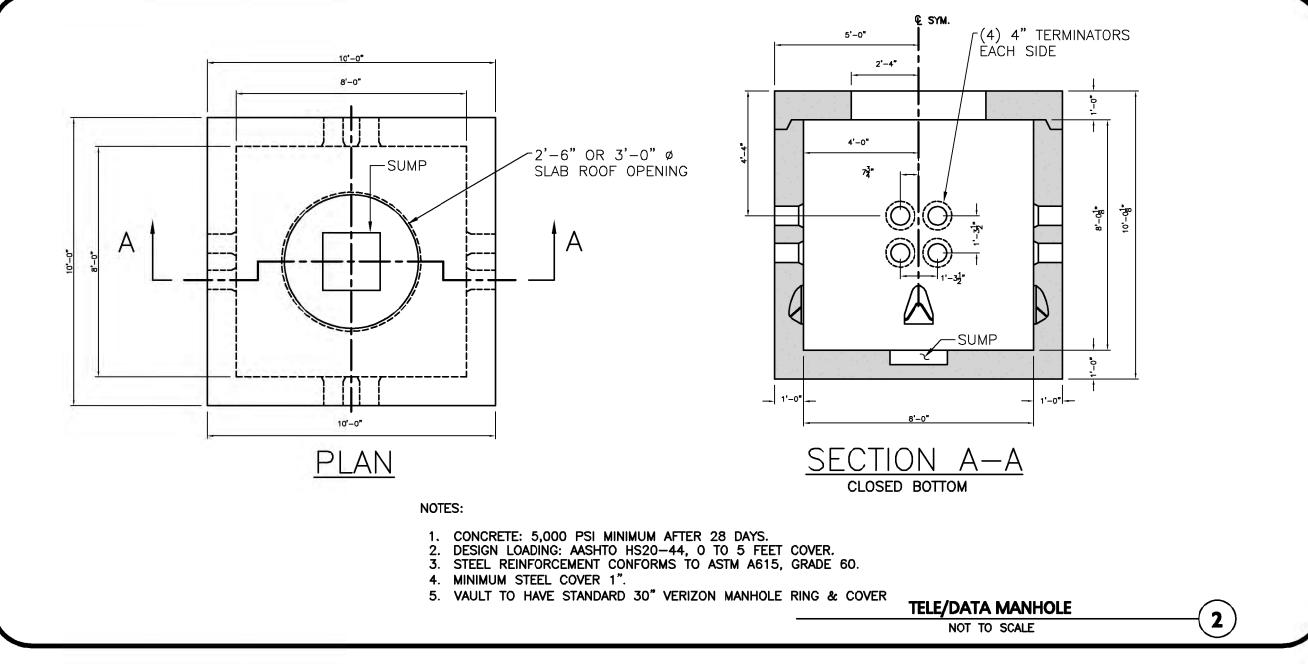

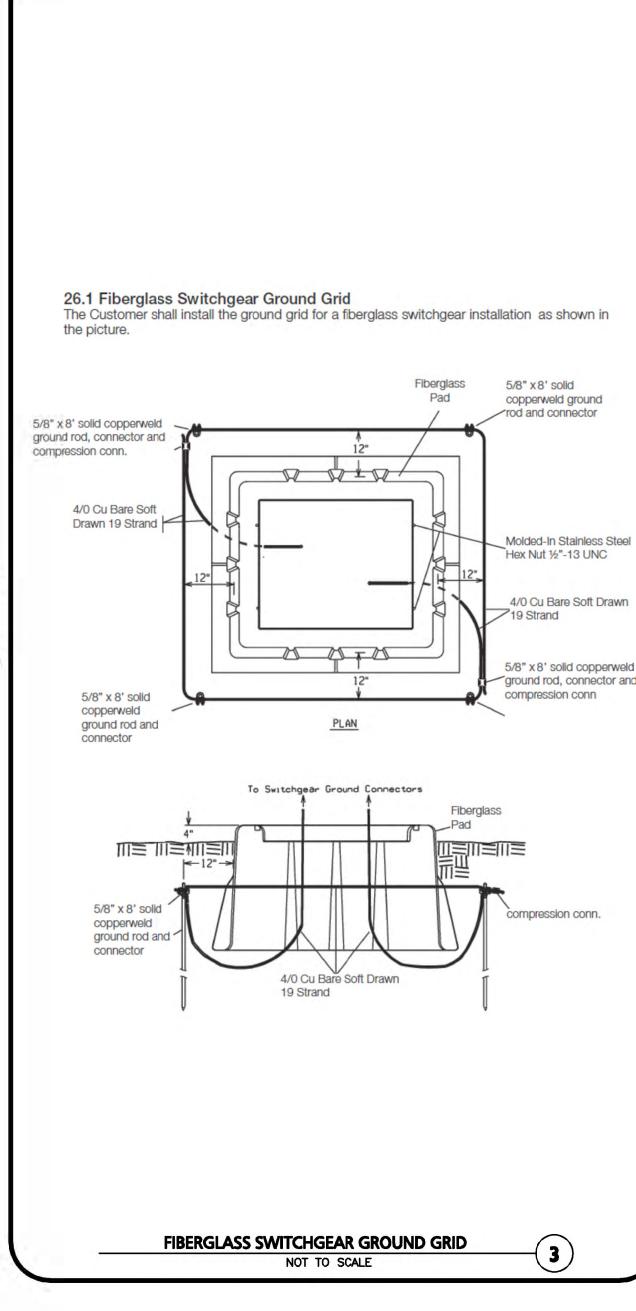

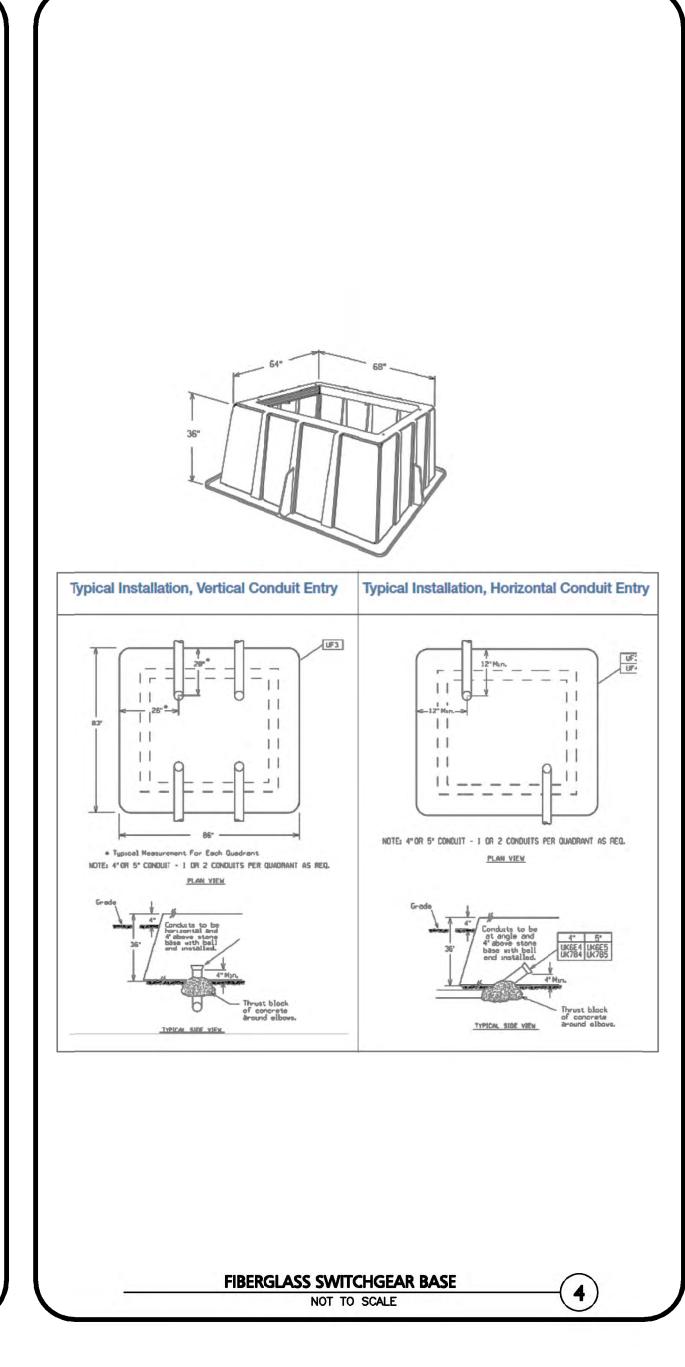

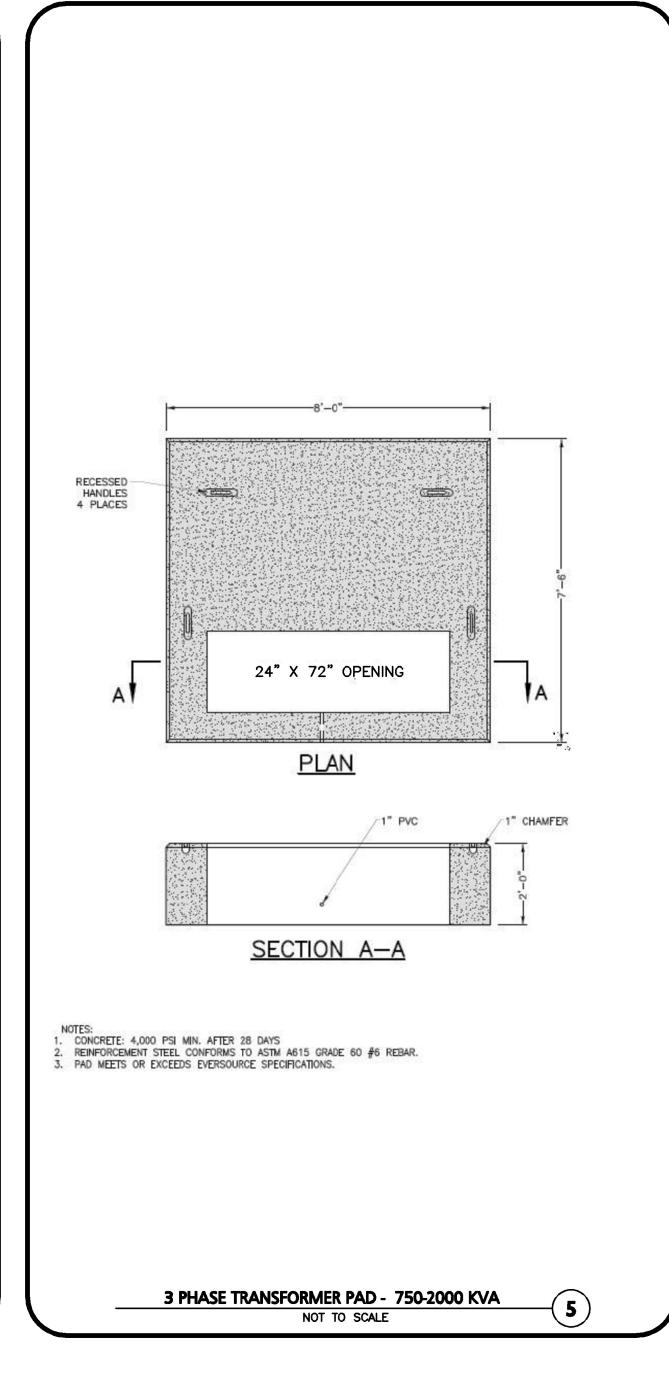

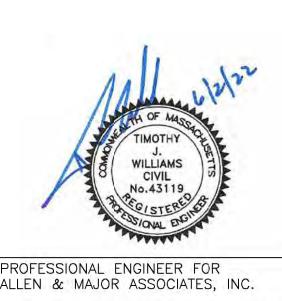

ALLEN & MAJOR ASSOCIATES, INC. 06/02/2022 Re-Issued to Con.Com. & ZBA 04/08/2022 Re-Issued to Con.Com. & ZBA 6 2/07/2022 Re-Issued to Conservation Commission 1/05/2022 | Re-Issued to Conservation Commission 4 | 11/11/2021 | Re-Issued to ZBA 3 9/01/2021 Re-Issued to ZBA 8/03/2021 Issued to Conservation Commission 3/31/2021 | Re-Issued to ZBA REV DATE DESCRIPTION

CCF QUANNAPOWITT PROPERTY COMPANY, LLC 185 DARTMOUTH STREET BOSTON, MA 02116

200-400 QUANNAPOWITT **PARKWAY** WAKEFIELD, MA 01880

1623-11 DATE: MARCH 16, 2021 N.T.S. DWG. NAME: C-1623-11.dwg **DESIGNED BY:** NCD | CHECKED BY:




civil engineering ◆ land surveying environmental consulting • landscape architecture www.allenmajor.com 100 COMMERCE WAY


WOBURN MA 01888-0118 TEL: (781) 935-6889 FAX: (781) 935-2896

WOBURN, MA ♦ LAKEVILLE, MA ♦ MANCHESTER, N THIS DRAWING HAS BEEN PREPARED IN DIGITAL FORMAT CLIENT/CLIENT'S REPRESENTATIVE OR CONSULTANTS MAY BE PROVIDED COPIES OF DRAWINGS AND SPECIFICATIONS FOR HIS/HER INFORMATION AND/OR SPECIFIC USE ON THIS PROJECT. DUE TO THE POTENTIAL THAT THE PROVIDED INFORMATION MAY BE MODIFIED UNINTENTIONALLY OR OTHERWISE, ALLEN & MAJOR ASSOCIATES INC. MAY REMOVE ALL INDICATION OF THE DOCUMENT AUTHORSHIP ON THE DIGITAL MEDIA. PRINTED REPRESENTATIONS OF PORTABLE DOCUMENT FORMAT OF THE DRAWINGS AND SPECIFICATIONS ISSUED SHALL BE THE ONLY RECORD COPIES OF

SHEET No.

DETAILS

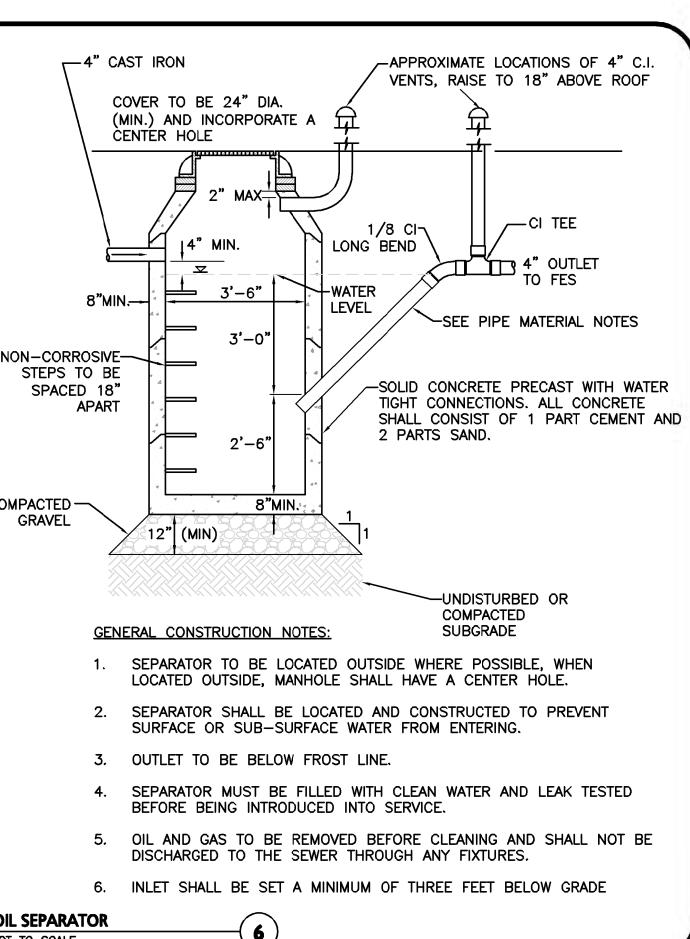

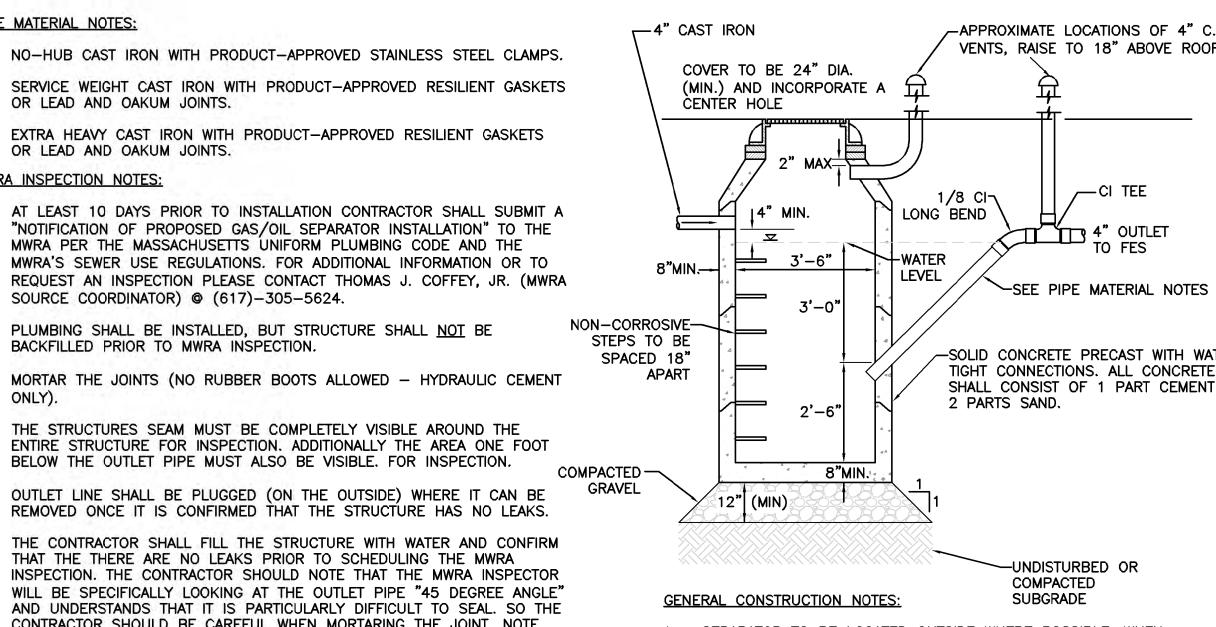

SERVICE WEIGHT CAST IRON WITH PRODUCT-APPROVED RESILIENT GASKETS OR LEAD AND OAKUM JOINTS.

PIPE MATERIAL NOTES:

EXTRA HEAVY CAST IRON WITH PRODUCT-APPROVED RESILIENT GASKETS OR LEAD AND OAKUM JOINTS. MWRA INSPECTION NOTES:

AT LEAST 10 DAYS PRIOR TO INSTALLATION CONTRACTOR SHALL SUBMIT A "NOTIFICATION OF PROPOSED GAS/OIL SEPARATOR INSTALLATION" TO THE MWRA PER THE MASSACHUSETTS UNIFORM PLUMBING CODE AND THE MWRA'S SEWER USE REGULATIONS. FOR ADDITIONAL INFORMATION OR TO REQUEST AN INSPECTION PLEASE CONTACT THOMAS J. COFFEY, JR. (MWRA SOURCE COORDINATOR) @ (617)-305-5624.

PLUMBING SHALL BE INSTALLED, BUT STRUCTURE SHALL NOT BE BACKFILLED PRIOR TO MWRA INSPECTION.

MORTAR THE JOINTS (NO RUBBER BOOTS ALLOWED - HYDRAULIC CEMENT

THE STRUCTURES SEAM MUST BE COMPLETELY VISIBLE AROUND THE ENTIRE STRUCTURE FOR INSPECTION. ADDITIONALLY THE AREA ONE FOOT BELOW THE OUTLET PIPE MUST ALSO BE VISIBLE. FOR INSPECTION.

OUTLET LINE SHALL BE PLUGGED (ON THE OUTSIDE) WHERE IT CAN BE REMOVED ONCE IT IS CONFIRMED THAT THE STRUCTURE HAS NO LEAKS.

THE CONTRACTOR SHALL FILL THE STRUCTURE WITH WATER AND CONFIRM THAT THE THERE ARE NO LEAKS PRIOR TO SCHEDULING THE MWRA INSPECTION. THE CONTRACTOR SHOULD NOTE THAT THE MWRA INSPECTOR WILL BE SPECIFICALLY LOOKING AT THE OUTLET PIPE "45 DEGREE ANGLE" AND UNDERSTANDS THAT IT IS PARTICULARLY DIFFICULT TO SEAL. SO THE CONTRACTOR SHOULD BE CAREFUL WHEN MORTARING THE JOINT. NOTE THE INSPECTOR WILL WANT TO INSPECT THE CONNECTION WITH THE TANK 1' BELOW THAT JOINT.

ONCE ON SITE, THE INSPECTOR WILL FIRST INSPECT THE STRUCTURE COMPLETELY FULL TO INSURE IT HAS NO LEAKS. THE INSPECTOR WILL THEN REQUIRE THAT THE OUTLET PIPE PLUG BE REMOVED TO OBSERVE THE WATER LEVEL. THE WATER LEVEL MUST BE OBSERVED AT LEAST 4" BELOW THE INLET PIPE.

THE CONTRACTOR MUST HAVE A 2" PUMP ON-SITE DURING THE

INSPECTION TO ALLOW THE INSPECTOR TO VERIFY THE INTERIOR MEASUREMENT OF THE TANK FOR CODE COMPLIANCE.

THE OUTLET PIPE MUST NOT STICK INTO THE STRUCTURE CHAMBER ANY MORE THAN ILLUSTRATED.

NOT TO SCALE

GAS/OIL SEPARATOR

ALLEN & MAJOR ASSOCIATES, INC.'S WORK PRODUCT. DRAWING TITLE:

Copyright ©2022 Allen & Major Associates, Inc.
All Rights Reserved

C-504

STORMWATER CHAMBER SPECIFICATIONS

- CHAMBERS SHALL BE STORMTECH SC-740, SC-310, OR APPROVED EQUAL.
- CHAMBERS SHALL BE MANUFACTURED FROM VIRGIN POLYPROPYLENE OR POLYETHYLENE RESINS.
- CHAMBER ROWS SHALL PROVIDE CONTINUOUS, UNOBSTRUCTED INTERNAL SPACE WITH NO INTERNAL SUPPORT PANELS THAT WOULD IMPEDE FLOW OR LIMIT ACCESS FOR INSPECTION. THE STRUCTURAL DESIGN OF THE CHAMBERS, THE STRUCTURAL BACKFILL, AND THE INSTALLATION REQUIREMENTS SHALL ENSURE THAT THE LOAD FACTORS SPECIFIED IN THE AASHTO LRFD

BRIDGE DESIGN SPECIFICATIONS, SECTION 12.12, ARE MET FOR:

1) LONG-DURATION DEAD LOADS AND 2) SHORT-DURATION LIVE

- LOADS, BASED ON THE AASHTO DESIGN TRUCK WITH CONSIDERATION FOR IMPACT AND MULTIPLE VEHICLE PRESENCES. CHAMBERS SHALL MEET ASTM F2922 (POLYETHYLENE) OR ASTM F2418 (POLYPROPYLENE), "STANDARD SPECIFICATION FOR THERMOPLASTIC CORRUGATED WALL STORMWATER COLLECTION
- CHAMBERS" CHAMBERS SHALL BE DESIGNED AND ALLOWABLE LOADS DETERMINED IN ACCORDANCE WITH ASTM F2787, "STANDARD PRACTICE FOR STRUCTURAL DESIGN OF THERMOPLASTIC
- CORRUGATED WALL STORMWATER COLLECTION CHAMBERS". ONLY CHAMBERS THAT ARE APPROVED BY THE SITE DESIGN ENGINEER WILL BE ALLOWED, THE CHAMBER MANUFACTURER SHALL SUBMIT THE FOLLOWING UPON REQUEST TO THE SITE DESIGN ENGINEER FOR APPROVAL BEFORE DELIVERING CHAMBERS
- TO THE PROJECT SITE: a. A STRUCTURAL EVALUATION SEALED BY A REGISTERED PROFESSIONAL ENGINEER THAT DEMONSTRATES THAT THE SAFETY FACTORS ARE GREATER THAN OR EQUAL TO 1.95 FOR DEAD LOAD AND 1.75 FOR LIVE LOAD, THE MINIMUM REQUIRED BY
- ASTM F2787 AND BY AASHTO FOR THERMOPLASTIC PIPE. A STRUCTURAL EVALUATION SEALED BY A REGISTERED PROFESSIONAL ENGINEER THAT DEMONSTRATES THAT THE LOAD FACTORS SPECIFIED IN THE AASHTO LRFD BRIDGE DESIGN SPECIFICATIONS, SECTION 12.12, ARE MET. THE 50 YEAR CREEP MODULUS DATA SPECIFIED IN ASTM F2418 OR ASTM F2922 MUST BE USED AS PART OF THE AASHTO STRUCTURAL
- STRUCTURAL CROSS SECTION DETAIL ON WHICH THE STRUCTURAL EVALUATION IS BASED.

CATCH BASIN

- SUMP DEPTH TBD BY

SITE DESIGN ENGINEER

(24" MIN. RECOMMENDED)

CHAMBERS AND END CAPS SHALL BE PRODUCED AT AN ISO 9001 CERTIFIED MANUFACTURING FACILITY.

EVALUATION TO VERIFY LONG-TERM PERFORMANCE.

IMPORTANT - NOTES FOR THE BIDDING AND INSTALLATION OF THE SC-310/SC-740 SYSTEM

- 1. STORMTECH SC-310 & SC-740 CHAMBERS SHALL NOT BE INSTALLED UNTIL THE MANUFACTURER'S REPRESENTATIVE HAS COMPLETED A PRE-CONSTRUCTION MEETING WITH THE INSTALLERS.
- 2. STORMTECH SC-310 & SC-740 CHAMBERS SHALL BE INSTALLED IN ACCORDANCE WITH THE "STORMTECH SC-310/SC-740/SC-780 CONSTRUCTION GUIDE". 3. CHAMBERS ARE NOT TO BE BACKFILLED WITH A DOZER OR AN EXCAVATOR SITUATED OVER THE CHAMBERS.

STORMTECH RECOMMENDS 3 BACKFILL METHODS:

- STONESHOOTER LOCATED OFF THE CHAMBER BED. BACKFILL AS ROWS ARE BUILT USING AN EXCAVATOR ON THE
- FOUNDATION STONE OR SUB-GRADE. BACKFILL FROM OUTSIDE THE EXCAVATION USING A LONG BOOM HOE OR EXCAVATOR.
- 4. THE FOUNDATION STONE SHALL BE LEVELED AND COMPACTED PRIOR TO PLACING CHAMBERS. 5. JOINTS BETWEEN CHAMBERS SHALL BE PROPERLY SEATED PRIOR
- TO PLACING STONE. 6. MAINTAIN MINIMUM - 6" (150 mm) SPACING BETWEEN THE
- CHAMBER ROWS. 7. EMBEDMENT STONE SURROUNDING CHAMBERS MUST BE A CLEAN, CRUSHED. ANGULAR STONE 3/4-2" (20-50 mm).
- 8. THE CONTRACTOR MUST REPORT ANY DISCREPANCIES WITH CHAMBER FOUNDATION MATERIALS BEARING CAPACITIES TO THE SITE DESIGN ENGINEER.
- 9. ADS RECOMMENDS THE USE OF "FLEXSTORM CATCH IT" INSERTS DURING CONSTRUCTION FOR ALL INLETS TO PROTECT THE SUBSURFACE STORMWATER MANAGEMENT SYSTEM FROM CONSTRUCTION SITE RUNOFF.

NOTES FOR CONSTRUCTION EQUIPMENT

- 1. STORMTECH SC-310 & SC-740 CHAMBERS SHALL BE INSTALLED IN ACCORDANCE WITH THE "STORMTECH SC-310/SC-740/DC-780
- CONSTRUCTION GUIDE". 2. THE USE OF CONSTRUCTION EQUIPMENT OVER SC-310 & SC-740
- CHAMBERS IS LIMITED: NO EQUIPMENT IS ALLOWED ON BARE CHAMBERS. NO RUBBER TIRED LOADERS, DUMP TRUCKS, OR EXCAVATORS ARE ALLOWED UNTIL PROPER FILL DEPTHS ARE REACHED IN

ACCORDANCE WITH THE "STORMTECH SC-310/SC-740/DC-780

CONSTRUCTION GUIDE". WEIGHT LIMITS FOR CONSTRUCTION EQUIPMENT CAN BE FOUND IN THE "STORMTECH SC-310/SC-740/DC-780 CONSTRUCTION

UNDER THE STORMTECH STANDARD WARRANTY.

3. FULL 36" (900 mm) OF STABILIZED COVER MATERIALS OVER THE CHAMBERS IS REQUIRED FOR DUMP TRUCK TRAVEL OR DUMPING. USE OF A DOZER TO PUSH EMBEDMENT STONE BETWEEN THE ROWS OF CHAMBERS MAY CAUSE DAMAGE TO THE CHAMBERS AND IS NOT AN ACCEPTABLE BACKFILL METHOD. ANY CHAMBERS DAMAGED BY THE "DUMP AND PUSH" METHOD ARE NOT COVERED

CONTACT STORMTECH AT 1-888-892-2694 WITH ANY QUESTIONS ON INSTALLATION REQUIREMENTS OR WEIGHT LIMITS FOR CONSTRUCTION EQUIPMENT.




70 INWOOD ROAD, SUITE 3 | ROCKY HILL | CT | 06067 860-529-8188 | 888-892-2694 | WWW.STORMTECH.COM

PART #: SC310EPE12B



MATERIAL LOCATION		DESCRIPTION	AASHTO MATERIAL CLASSIFICATIONS	COMPACTION / DENSITY REQUIREMENT
D	FINAL FILL: FILL MATERIAL FOR LAYER 'D' STARTS FROM THE TOP OF THE 'C' LAYER TO THE BOTTOM OF FLEXIBLE PAVEMENT OR UNPAVED FINISHED GRADE ABOVE. NOTE THAT PAVEMENT SUB-BASE MAY BE PART OF THE 'D' LAYER	ANY SOIL/ROCK MATERIALS, NATIVE SOILS, OR PER ENGINEER'S PLANS. CHECK PLANS FOR PAVEMENT SUB-GRADE REQUIREMENTS.	N/A	PREPARE PER SITE DESIGN ENGINEER'S PLANS. PAVED INSTALLATIONS MAY HAVE STRINGENT MATERIAL AND PREPARATION REQUIREMENTS.
С	INITIAL FILL: FILL MATERIAL FOR LAYER 'C' STARTS FROM THE TOP OF THE EMBEDMENT STONE ('B' LAYER) TO 18" (450 mm) ABOVE THE TOP OF THE CHAMBER. NOTE THAT PAVEMENT SUB-BASE MAY BE A PART OF THE 'C' LAYER.	GRANULAR WELL-GRADED SOIL/AGGREGATE MIXTURES, <35% FINES OR PROCESSED AGGREGATE. MOST PAVEMENT SUB-BASE MATERIALS CAN BE USED IN LIEU OF THIS LAYER.	AASHTO M145 ¹ A-1, A-2-4, A-3 OR AASHTO M43 ¹ 3, 357, 4, 467, 5, 56, 57, 6, 67, 68, 7, 78, 8, 89, 9, 10	BEGIN COMPACTIONS AFTER 12" (300 mm) OF MATERIAL OVER THE CHAMBERS IS REACHED. COMPACT ADDITIONAL LAYERS IN 6" (150 mm) MAX LIFTS TO A MIN. 95% PROCTOR DENSITY FOR WELL GRADED MATERIAL AND 95% RELATIVE DENSITY FOR PROCESSED AGGREGATE MATERIALS. ROLLER GROSS VEHICLE WEIGHT NOT TO EXCEED 12,000 lbs (53 kN). DYNAMIC FORCE NOT TO EXCEED 20,000 lbs (89 kN).
В	EMBEDMENT STONE: FILL SURROUNDING THE CHAMBERS FROM THE FOUNDATION STONE ('A' LAYER) TO THE 'C' LAYER ABOVE.	CLEAN, CRUSHED, ANGULAR STONE, NOMINAL SIZE DISTRIBUTION BETWEEN 3/4-2 INCH (20-50 mm)	AASHTO M43¹ 3, 357, 4, 467, 5, 56, 57	NO COMPACTION REQUIRED.
Α	FOUNDATIONSTONE: FILL BELOW CHAMBERS FROM THE SUB-GRADE UP TO THE FOOT (BOTTOM) OF THE CHAMBER.	CLEAN, CRUSHED, ANGULAR STONE, NOMINAL SIZE DISTRIBUTION BETWEEN 3/4-2 INCH (20-50 mm)	AASHTO M43¹ 3, 357, 4, 467, 5, 56, 57	PLATE COMPACT OR ROLL TO ACHIEVE A FLAT SURFACE. 2 3

- 1. THE LISTED AASHTO DESIGNATIONS ARE FOR GRADATIONS ONLY. THE STONE MUST ALSO BE CLEAN, CRUSHED, ANGULAR. FOR EXAMPLE, A SPECIFICATION FOR #4 STONE WOULD STATE:
- "CLEAN, CRUSHED, ANGULAR NO. 4 (AASHTO M43) STONE". 2. STORMTECH COMPACTION REQUIREMENTS ARE MET FOR 'A' LOCATION MATERIALS WHEN PLACED AND COMPACTED IN 6" (150 mm) (MAX) LIFTS USING TWO FULL COVERAGES WITH A
- 3. WHERE INFILTRATION SURFACES MAY BE COMPROMISED BY COMPACTION, FOR STANDARD DESIGN LOAD CONDITIONS, A FLAT SURFACE MAY BE ACHIEVED BY RAKING OR DRAGGING WITHOUT
- COMPACTION EQUIPMENT. FOR SPECIAL LOAD DESIGNS, CONTACT STORMTECH FOR COMPACTION REQUIREMENTS.

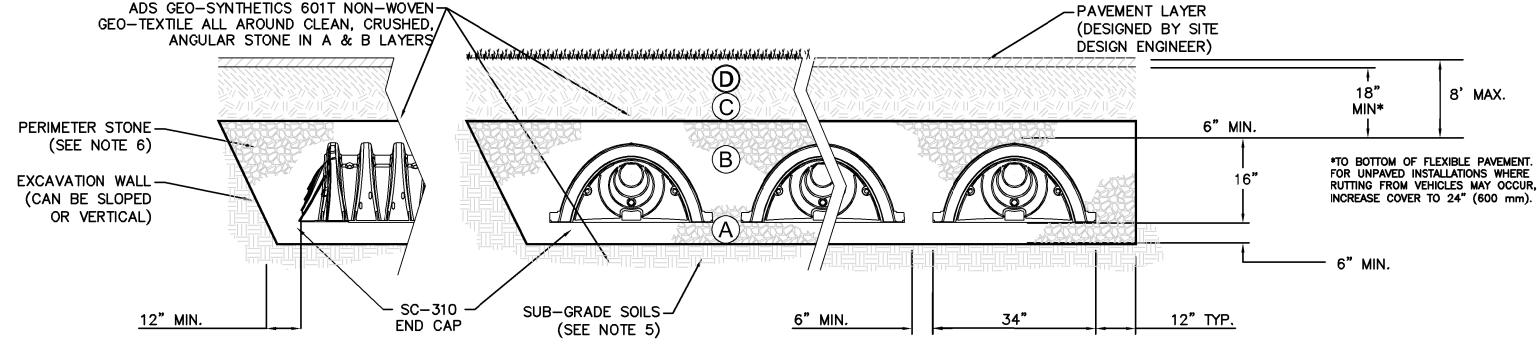


ACCEPTABLE FILL MATERIALS: STORMTECH SC-310 CHAMBER SYSTEMS 2

NOT TO SCALE

- SC-310 CHAMBERS SHALL CONFORM TO THE REQUIREMENTS OF ASTM F2418 "STANDARD SPECIFICATION FOR POLYPROPYLENE (PP) CORRUGATED WALL STORMWATER COLLECTION CHAMBERS", OR ASTM F2922 "STANDARD SPECIFICATION
- FOR POLYETHYLENE (PE) CORRUGATED WALL STORMWATER COLLECTION CHAMBERS". 2. SC-310 CHAMBERS SHALL BE DESIGNED IN ACCORDANCE WITH ASTM F2787 "STANDARD PRACTICE FOR STRUCTURAL DESIGN
- OF THERMOPLASTIC CORRUGATED WALL STORMWATER COLLECTION CHAMBERS" 3. "ACCEPTABLE FILL MATERIALS" TABLE ABOVE PROVIDES MATERIAL LOCATIONS, DESCRIPTIONS, GRADATIONS, AND COMPACTION
- REQUIREMENTS FOR FOUNDATION, EMBEDMENT, AND FILL MATERIALS.
- 4. THE "SITE DESIGN ENGINEER" REFERS TO THE ENGINEER RESPONSIBLE FOR THE DESIGN AND LAYOUT OF THE STORMTECH CHAMBERS FOR THIS PROJECT.
- EXISTING FILL MATERIAL TO BE REMOVED (WHERE ENCOUNTERED) WITHIN LIMITS OF THE PROPOSED INFILTRATIONS SYSTEM DOWN TO THE NATIVE SOIL AND BACKFILLED WITH TITLE V SAND.
- PERIMETER STONE MUST BE EXTENDED HORIZONTALLY TO THE EXCAVATION WALL FOR BOTH VERTICAL AND SLOPED
- ONCE LAYER 'C' IS PLACED, ANY SOIL/MATERIAL CAN BE PLACED IN LAYER 'D' UP TO THE FINISHED GRADE. MOST PAVEMENT SUB-BASE SOILS CAN BE USED TO REPLACE THE MATERIAL REQUIREMENTS OF LAYER 'C' OR 'D' AT THE SITE

DESIGN ENGINEER'S DISCRETION.

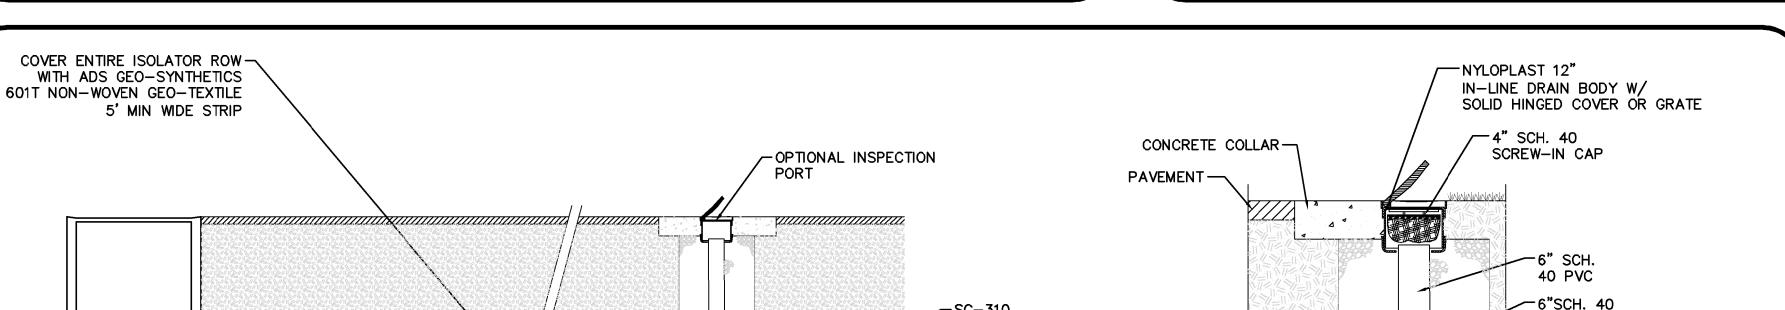

TYPICAL SECTIONAL VIEW

-SC-740 CHAMBER 2" HDPE ACCESS PIPE REQUIRED USE FACTORY PRE-FABRICATED END CAP TWO LAYERS OF ADS 315WTK WOVEN-GEOTEXTILE BETWEEN STONE BASE AND CHAMBERS (MINIMUM 4' WIDE STRIP)

1. INSPECTION PORTS MAY BE CONNECTED THROUGH ANY ADS GEO-SYNTHETICS 601T NON-WOVEN-CHAMBER CORRUGATION VALLEY GEO-TEXTILE ALL AROUND CLEAN, CRUSHED, 2. ALL SCHEDULE 40 FITTINGS TO BE SOLVENT CEMENTED. ANGULAR STONE IN A & B LAYERS


ISOLATOR ROW & INSPECTION PORT

INSPECTION PORT DETAIL

─ INSERTA-TEE AT CHAMBER JOINTS CONVEYANCE PIPE MATERIAL MAY VARY (PVC, HDPE, ETC.) INSERTA TEE TO BE INSTALLED, CENTERED OVER CORRUGATION PLACE ADSPLUS WOVEN GEOTEXTILE (CENTERED ON INSERTA-TEE INLET) OVER SIDE VIEW SECTION A-A BEDDING STONE FOR SCOUR PROTECTION AT SIDE INLET CONNECTIONS. GEOTEXTILE MUST EXTEND 6" (150 mm) PAST CHAMBER HEIGHT FROM BASE OF CHAMBER (X) 4" (100 mm) SC-310 4" (100 mm) SC-740 10" (250 mm) 4" (100 mm) DC-780 10" (250 mm) 6" (150 mm) MC-3500 12" (300 mm) 12" (300 mm) PART NUMBERS WILL VARY BASED ON INLET PIPE MATERIALS. INSERTA TEE FITTINGS AVAILABLE FOR SDR 26, SDR 35, SCH 40 IPS CONTACT STORMTECH FOR MORE INFORMATION. GASKETED & SOLVENT WELD, N-12, HP STORM, C-900 OR DUCTILE IRON

INSERTA TEE DETAIL

NOT TO SCALE

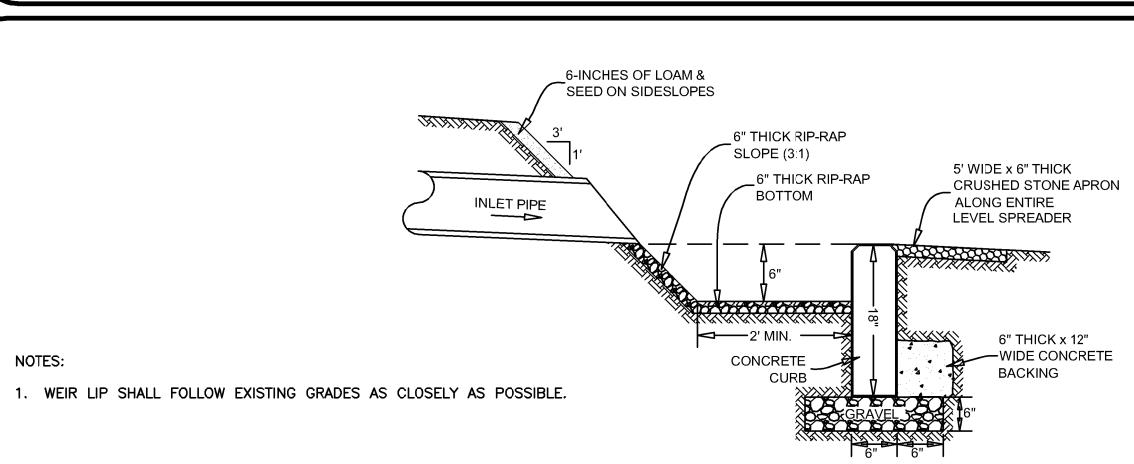

STORMTECH ISOLATOR ROW*

INSTALL JOINT SEAL (TYPICAL) CONCRETE CURB WEIR TOP OF WEIR CURB WALL MUST BE LEVEL WALL PER SECTION RIP-RAP BOTTOM

2' MIN. 2' LENGTH OF CONCRETE CURB ON EITHER SIDE TOP ELEVATION 0.25' HIGHER THAN WEIR WALL LOAM & SEED SIDESLOPES RIP-RAP APRON **PLAN VIEW**

COUPLING

CONNECTION DETAIL

LEVEL SPREADER NOT TO SCALE



PROFESSIONAL ENGINEER FOR ALLEN & MAJOR ASSOCIATES, INC.

8 06/02/2022 Re-Issued		Re-Issued to Con.Com. & ZBA
7	04/08/2022	Re-Issued to Con.Com. & ZBA
6	2/07/2022	Re-Issued to Conservation Commission
5	1/05/2022	Re-Issued to Conservation Commission
4	11/11/2021	Re-Issued to ZBA
3	9/01/2021	Re-Issued to ZBA
2	8/03/2021	Issued to Conservation Commission
1	3/31/2021	Re-Issued to ZBA
REV	DATE	DESCRIPTION

CCF QUANNAPOWITT PROPERTY COMPANY, LLC 185 DARTMOUTH STREET BOSTON, MA 02116

200-400 QUANNAPOWITT **PARKWAY** WAKEFIELD, MA 01880

1623-11 DATE: MARCH 16, 202 N.T.S. DWG. NAME: C-1623-11.dv NCD | CHECKED BY: **DESIGNED BY:**



civil engineering ◆ land surveying environmental consulting • landscape architecture www.allenmajor.com 100 COMMERCE WAY

WOBURN MA 01888-0118 TEL: (781) 935-6889 FAX: (781) 935-2896

WOBURN, MA ♦ LAKEVILLE, MA ♦ MANCHESTER, N

THIS DRAWING HAS BEEN PREPARED IN DIGITAL FORMAT CLIENT/CLIENT'S REPRESENTATIVE OR CONSULTANTS MAY B PROVIDED COPIES OF DRAWINGS AND SPECIFICATIONS FOR HIS/HER INFORMATION AND/OR SPECIFIC USE ON THIS PROJECT. DUE TO THE POTENTIAL THAT THE PROVIDED INFORMATION MAY BE MODIFIED UNINTENTIONALLY OR OTHERWISE, ALLEN & MAJOR ASSOCIATES INC. MAY REMOVE ALL INDICATION OF THE DOCUMENT AUTHORSHIP ON THE DIGITAL MEDIA. PRINTED REPRESENTATIONS OF PORTABLE DOCUMENT FORMAT OF THE DRAWINGS AND SPECIFICATIONS ISSUED SHALL BE THE ONLY RECORD COPIES OF ALLEN & MAJOR ASSOCIATES, INC.'S WORK PRODUCT.

DRAWING TITLE: DETAILS

C-505 Copyright ©2022 Allen & Major Associates, Inc.